Date	Received
TOWN	CLERK
Ву:	



TOWN OF ACTON MASSACHUSETTS

Date I	Rece	eived
BOARD	OF	APPEALS
Ву:		

BOARD OF APPEALS (FORM 4) PETITION FOR A SPECIAL PERMIT

Sept. 5 \$ 2013 I/We hereby petition the Board of Appeals for a public hearing and a special permit under Section 8, 1, 5 of the Zoning By-Law, as provided by G.L. Chapter 40A, Section 9 to allow: We seek approval for an exception to the FAR restriction (Acton Bylaws sec 8.1.3) so that we may build a full basement in the new house we plan to build on this property. The existing lot is nonconforming, so the zoning bylaws limit us to the FAR of the existing house. Our new home has been permitted by right, except that we have had to reduce part of the foundation from a full basement to a crawl space in order to reduce the FAR. We seek approval to build a full basement under the entire house rather than just part of it. We have striven to make the new house sensitive to the neighborhood and respectful of the lot's size. - The proposed house meets all the setback requirements and is set further from the street and both sides of the property than the existing house. The proposed house's footprint is significantly smaller than the existing house. The approval we seek for the basement will not change the outward appearance of the house in any way. It won't affect the number of bedrooms or bathrooms or people living in the house. Respectfully submitted Signed OFFICE USE ONLY four copies of petition? + co Rom (Petitioner) Location map? Plot plans? Additional briefs? List of abutters and other interested parties? (Owner of record) Fee - \$100.00/1-25 abutters \$125.00/26+ abutters? Address Next Hearing Date? No Phone #

A special permit may be granted by the Board of Appeals under specific paragraphs of the Zoning By-Law. In general, the use may be permitted if the special permit will be in harmony with the general provisions and intent of the Zoning By-Law and if all requirements or conditions for the granting of such a permit, as contained in the specific sections of the Zoning By-Law, have been satisfied.



Zoning Enforcement Officer

TOWN OF ACTON

472 Main Street Acton, Massachusetts 01720 Telephone (978) 929-6631 Fax (978) 929-6340 planning@acton-ma.gov www.acton-ma.gov

August 21, 2013

Mr. John Gilbert c/o Mr. Stephen Mielke 260 Old Harvard Road Boxborough, MA 01719

Re: 2nd Review - Proposed Total Demolition of Existing Single Family Residential Dwelling and Construction of New Larger Single Family Residential Dwelling on a Nonconforming Lot
112 Stow Street, Acton, MA 01720

Dear Mr. Mielke,

The Planning Department has reviewed the revised basement plan and accompanying square footage table which you submitted as it pertains to your pending building permit application and CAN NOT approve the building permit at this time. As described in the building permit application and the drawings currently submitted, the pending building permit is seeking approval to "demolish existing home and construct new home".

As you may or may not be aware of, the subject property is located within an R-2 (Residence 2) zoning district. Property located within this zoning district typically requires a minimum of 150'-0" of lot frontage and a minimum of 20,000 square feet of lot area. Unfortunately, the subject property does not comply with the minimum lot frontage requirement. According to the Engineering Department's Property Index Cards, the subject property in question currently has only 100'-0" of lot frontage. However, the lot does comply with the minimum lot area requirement. There are multiple pieces of property with similar circumstances located throughout town. These types of properties (112 Stow Street included) are known as and referred to as "Nonconforming Lots". Section 8 of the Town of Acton's Zoning Bylaw governs Nonconforming properties. More specifically, the following subsection of the Bylaw is applicable in this instance when beginning the building permit review process:

- 8.1.3 Replacement of Single- and Two-Family Dwellings on Nonconforming Lots A
 STRUCTURE in single family residential USE on a nonconforming LOT may be razed and rebuilt for single family residential USE; and a STRUCTURE in two-family residential USE on a nonconforming LOT may be razed and rebuilt for two-family residential USE; in both cases subject to the following conditions and limitations:
 - 8.1.3.1 The replacement STRUCTURE shall not exceed the FLOOR AREA RATIO on the

- LOT of the STRUCTURE that existed on the LOT before it was razed or damaged.
- 8.1.3.2 The replacement STRUCTURE shall meet all minimum yard and maximum height requirements of this Bylaw.
- 8.1.3.3 In the absence of architectural and plot plans for the existing structure to be razed, the FLOOR AREA RATIO shall be determined by using the information on record at the Town of Acton Assessor's office.
- 8.1.3.4 Additions to the replacement STRUCTURE may be made after two years following the date of initial occupancy of the replacement STRUCTURE, if otherwise permissible and subject to any permits and special permits that may be required.

Simply stated, if a structure exists on a non-conforming lot, that structure is permitted to be demolished, but the replacement structure CAN NOT exceed the Net Floor Area of the previous structure prior to its demolition. The footprint of the new dwelling structure is not restricted to having to match the previous dwelling's footprint, but the Net Floor Area's of past and proposed dwelling structures must be the same, if not less. In addition, if approved, once the new structure is completed and a Certificate of Occupancy is issued by the Building Commissioner, a minimum of two years must elapse before any additions or new square footage is permitted to be added to the dwelling structure.

Information obtained from the Town of Acton Property Assessor's Office, indicates that the existing structure currently consists of approximately 2,134 square feet of Gross Floor Area (First Floor –928 ft², Second Floor (Attic) – 288 ft², Enclosed and Finished Porch – 110 ft², Basement – 808 ft²). In order to permit the tear down of the existing structure, and the construction of a new single family residential dwelling administratively as of right, the overall maximum permitted size of said new proposed dwelling could not exceed a cumulative total of 2,134 square feet. As previously noted, the building permit currently submitted seeks approval to construct a new residential dwelling in excess of 2,134 square foot maximum permitted. Due to the aforementioned information, and as a result, I CAN NOT approve the building permit as currently submitted.

You have revised the original basement plan to clearly delineate a new mechanical room as well as raised the concrete floor slab in a portion of the basement so that the floor-to-ceiling height within this area will be less than 6'-0" (72"). As per the Town of Acton's Zoning Bylaw, both of these areas are permitted reductions to the overall Floor Area Ratio of this particular project. While the revised basement layout does in fact reduce the overall square footage proposed for reconstruction, unfortunately, the revised layout does not bring the proposed new home construction into compliance with the dimensional regulations set forth in Section 8.1.3 of the Zoning Bylaw. Furthermore, the table of square footage calculations provided, which includes bathrooms and stairways being deducted, as well as the basement modifications being accounted for, clearly indicates that the revised building design remains approximately +/- 300 square feet in excess of the maximum permitted amount of square footage allowed to be rebuilt.

Therefore, should you wish to continue to pursue the submitted building permit application, there are two options available to you. The options are as follows and you may select either one:

Option 1 – Section 8.1.5 of the Zoning Bylaw becomes applicable and it states the following:

8.1.5 In all other cases, the Board of Appeals may, by special permit, allow such reconstruction of, or extension, alteration or change to a single or two-family residential STRUCTURE on a nonconforming LOT, where it determines either that the proposed modification does not increase the nonconformity or, if the proposed modification does increase the nonconformity, it will not be substantially more detrimental to the neighborhood than the existing STRUCTURE on the nonconforming LOT.

This option presumes that the application submitted to the Zoning Board of Appeals would look identical in nature to the building permit currently submitted to the Town for review. Should the Zoning Board of Appeals approve such a Special Permit for the larger overall footprint and square footage, then you would be permitted to continue to move forward with the building permit application.

Zoning Board of Appeals applications for Special Permits may be obtained by contacting Cheryl Frazier, Secretary for the Zoning Board of Appeals, at (978) 929-6443 or cfrazier@acton-ma.gov during regular business hours.

Option 2 – You may further modify the submitted building permit drawings to reduce the overall size of the proposed structure to comply with the maximum permitted dimensional requirements and then resubmit the plans for further staff review.

If you have any questions, comments or concerns regarding this matter, please feel free to contact our office at (978) 929-6631, Monday through Friday (except for holidays) between the hours of 8:00 am and 5:00 pm.

Sincerely,

Scott A. Mutch

Zoning Enforcement Officer & Assistant Town Planner



Brian McMullen Assistant Assessor

> Locus: Parcel:

112 STOW ST

H2-67

Location	Parcel ID	Owner	Co-Owner	Mailing Address	City ST Zip
H2-136	117 STOW ST	GOULET RUTH CB	GOULET DAVID A	119 STOW ST	ACTON, MA 01720
H2-51	119 STOW ST BEHIND	GOULET RUTH CB	GOULET DAVID A	119 STOW STREET	ACTON, MA 01720
H2-52	111 STOW ST BEHIND	GOULET RUTH CB	GOULET DAVID A	119 STOW STREET	ACTON, MA 01720
H2-54	119 STOW ST	GOULET RUTH CB	GOULET DAVID A	119 STOW ST	ACTON, MA 01720
H2-55	111 STOW ST	CLEMENT LUC	CLEMENT ALISON A	111 STOW ST	ACTON, MA 01720
H2-56	107 STOW ST	O'CALLAGHAN STEPHEN E	MURRAY SARAH L	107 STOW ST	ACTON, MA 01720
H2-56-1	105 STOW ST	REITSMA DAVID M	REITSMA JENA L	105 STOW ST	ACTON, MA 01720
H2-57	101 STOW ST	LAGRASSA PETER C	LAGRASSA MICHELLE	101 STOW ST	ACTON, MA 01720
H2-63	124 STOW ST	ESCHENBRENNER RONALD C	RYLE REBECCA B	122 STOW RD	ACTON, MA 01720
H2-64	122 STOW ST	ESCHENBRENNER RONALD C	RYLE REBECCA B	122 STOW ST	ACTON, MA 01720
H2-65	120 STOW ST	SIRONEN DAVID E TRUSTEE	SIRONEN JOYCE W TRUSTEE	120 STOW ST	ACTON, MA 01720
H2-66	116 STOW ST	HEARN PATRICK + FRANCES TR	STOW STREET REAL EST TRUST	116 STOW ST	ACTON, MA 01720
H2-68	110 STOW ST	DIESL WARREN F	VERONICA K	110 STOW STREET	ACTON, MA 01720
H2-69	108 STOW ST	SEABURG SCOTT H		108 STOW ST	ACTON, MA 01720
H2-70	106 STOW ST	HANNON MARTHA J		106 STOW ST	ACTON, MA 01720
H2-71	106 STOW ST	HANNON MARTHA J		106 STOW ST	ACTON, MA 01720
H2-75	18 ROBBINS ST	BUTLER BRIAN O	BUTLER DARLENE A	18 ROBBINS ST	ACTON, MA 01720
H2-82	63 LIBERTY ST	ISOGAI KAZUYUKI	ISOGAI NAOKO	63 LIBERTY ST	ACTON, MA 01720
H2-96	67 LIBERTY ST	HIGDON BERNICE M TRUSTEE	MERRITT DAVID TRUSTEE	67 LIBERTY ST	ACTON, MA 01720

Acton, MA 01720
Telephone (978) 929-6621
Fax (978) 929-6340

Abutters and owners of land directly opposite on any public or private street or way and abutters to the abutters within three hundred feet of the property line all as they appear on the most recent applicable tax list.


HEARING NOTICES FOR ALL SPECIAL PERMITS MUST BE SENT TO THE PLANNING BOARD, TOWN HALL IN THE FOLLOWING TOWNS:

Boxborough, MA 01729 Carlisle, MA 01741 Maynard, MA 01754 Stow, MA 01775 Concord, MA 01742 Westford, MA 01886 Littleton, MA 01460 Sudbury, MA 01776


Marty Abbott

Assessor's Clerk

29-Aug-13

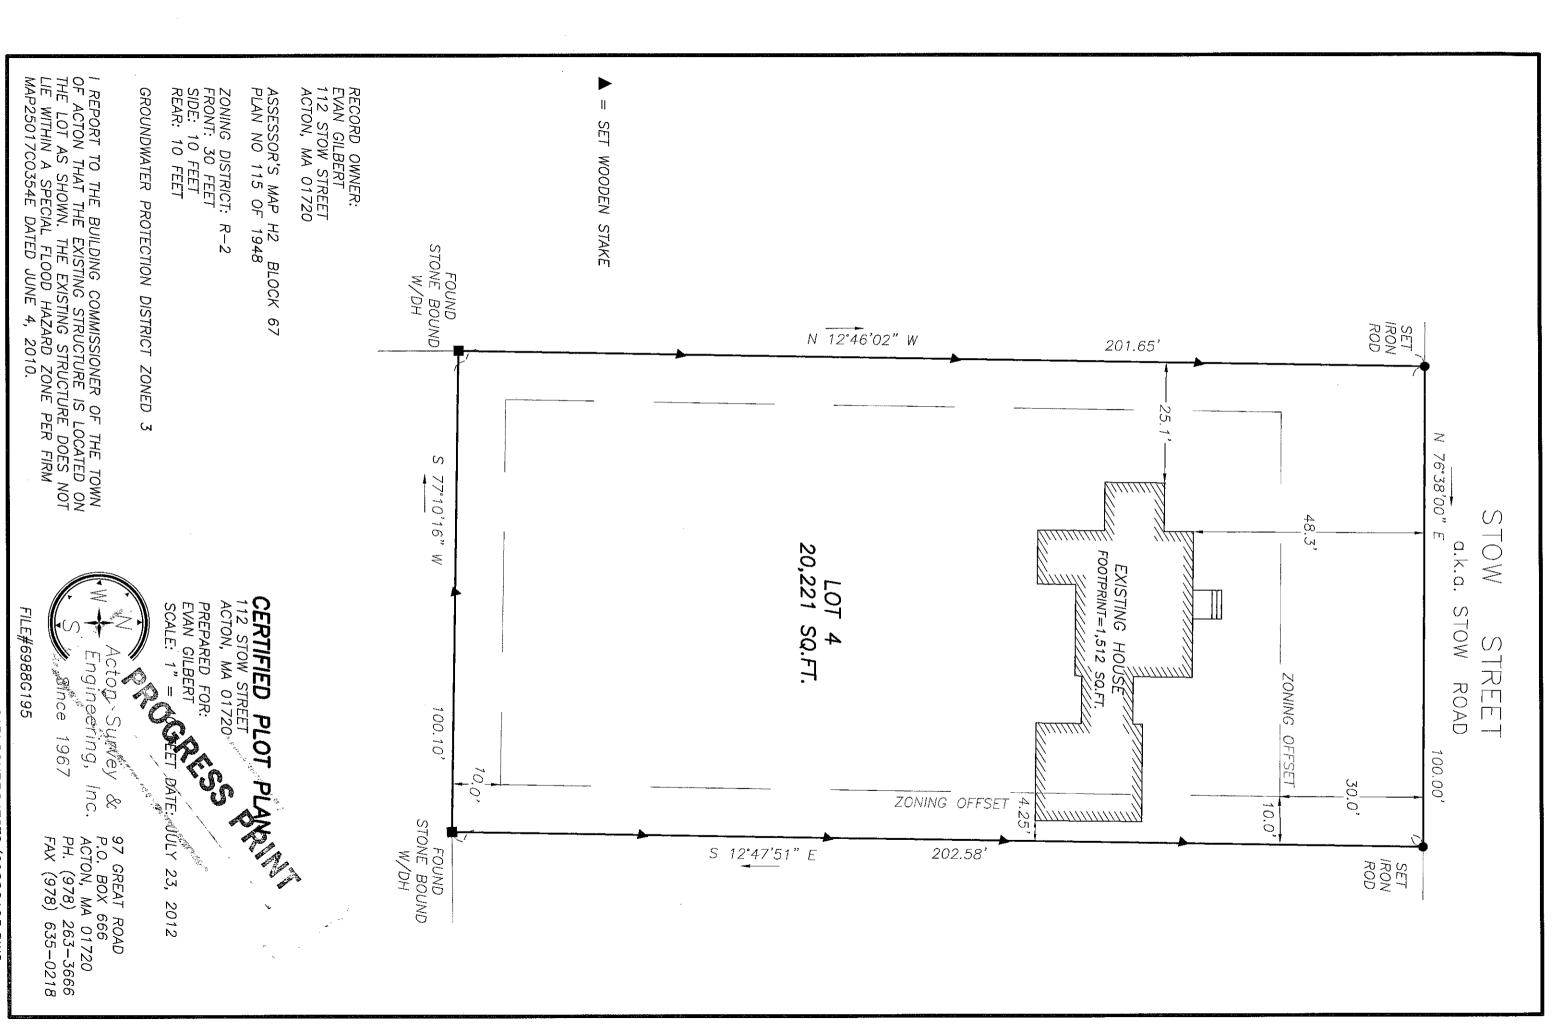

Acton GIS Viewer 9/4/2013

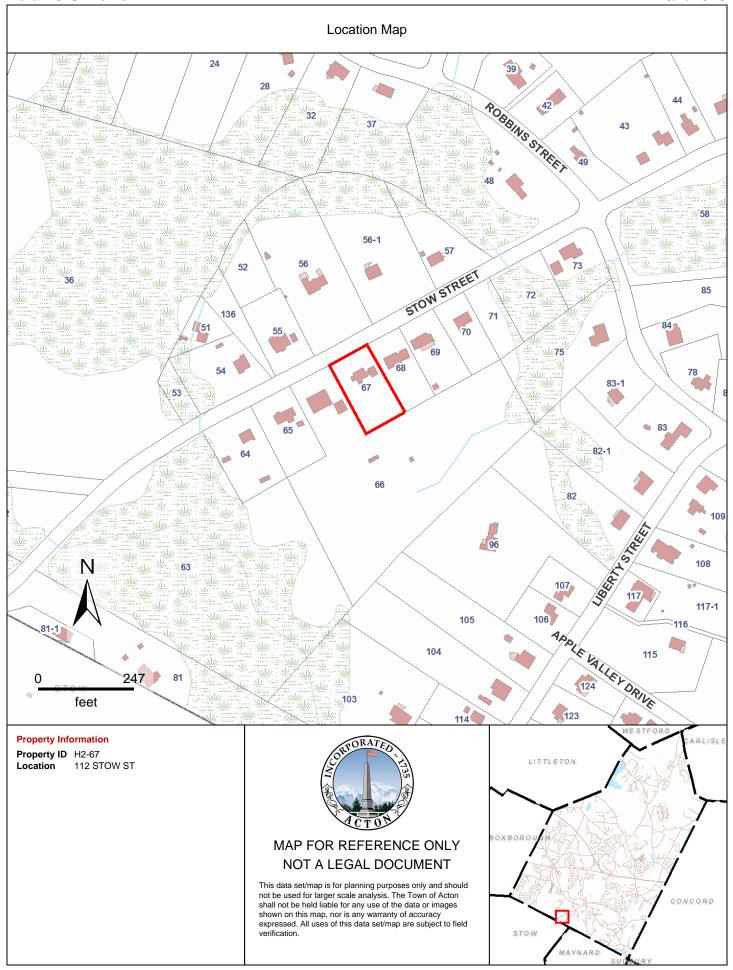

Town of Acton, MA	Map Legend
STRUCTURES BUILDING DECK FOUNDATION FUEL TANK MOBILE PORCH RUINS SMOKESTACK WATERTANK	
□ PARCELS	
DEP WETLANDS WET AREAS PONDS	
DEP RIVERS & STREAMS	
TOWN BOUNDARIES	

GILBERT RESIDENCE

ACTON, MA 112 STOW STREET 01720

D AVID WHITN \prec

 \triangleright 70 \cap エ П \cap

49 LINDEN STREET ARLINGTON, MA 02476 781 643 0759

DRAWING INDEX

- A0.1 A0.2 Notes & Legends Site Plan
- A1.0 A1.1 A1.2 A1.3 Basement Plan First Floor Plan
- Roof Plan Second Floor Plan
- South Elevation
- A2.1 A2.2 A2.3 A2.4 West Elevation North Elevation East Elevation
- A4.12 Interior Elevs: Bath I
 A4.13 Interior Elevs: Kit/Din/Liv Room
 A4.14 Interior Elevs: Kit/Din/Liv Room
 A4.15 Interior Elevs: Office
 A4.21 Interior Elevs: Second Floor Hall
 A4.22 Interior Elevs: Master Bedroom
 A4.23 Interior Elevs: Master Bath A4.24 Interior Elevs: Master Bath A4.25 Interior Elevs: Bath 3 A4.26 Interior Elevs: Bedroom 2 A4.27 Interior Elevs: Bedroom 3 A4.11 Interior Elevs: First Floor Hall
- A5.1 A5.2 A5.3 A5.4 Door & Hardware Schedules Window Schedule Finish Schedule
- Plumbing & Insulation Schedules
- Details: Foundation
- Details: Eaves & Rakes
- Details: Exterior Landings Details: Walls & Closets
- Details: Interior

- **Details: Cubbies**
- A6.1 A6.2 A6.3 A6.4 A6.5 A6.6 A6.7 Details: Entry Canopy Details: Fireplace
- S1.1 S1.2 S1.3 First Floor Framing Plan Second Floor Framing Plan Roof Framing Plan
- E0.1 E1.0 E1.1 E1.2 First Floor Electric Plan Electric Notes & Legends Basement Electric Plan

Second Floor Electric Plan

REVISED SET 8.9.13

\bigcirc П \mathbf{Z} I ∇ \triangleright Г \mathbf{Z} 0 \vdash [I]

S

- 5 VERIFY CONDITIONS: CONTRACTOR TO CONFIRM EXISTING CONDITIONS AND NOTIFY ARCHITECT IF ANY CONDITIONS DO NOT AGREE WITH DRAWINGS. DO NOT SCALE OFF DRAWINGS. CONTACT ARCHITECT FOR CLARIFICATION IF REQUIRED.
- UTILITIES: CONTRACTOR TO FAMILIARIZE HIMSELF WITH ALL UTILITIES AT GRADE, ABOVE GRADE, AND UNDERGROUND, INCLUDING UTILITY PIPES AND STRUCTURES. THE CONTRACTOR SHALL KERIFY THE LOCATIONS OF ALL UTILITIES WITH UTILITY OF START OF CONSTRUCTION. THE CONTRACTOR SHALL TAKE SOLE RESPONSIBILITY FOR THE COST INCURRED BY AND REPLACEMENT OF ANY DAMAGE TO UTILITIES ON THE SITE. THE CONTRACTOR SHALL CONTACT MASSACHUSETTS "DIG SAFE" AT 1—800—322—4844 TO FIELD LOCATE ALL UTILITIES PRIOR TO STARTING WORK.
- PROTECT SITE: PROTECT ALL EXISTING TREES & SHRUBS ON THE SITE DURING CONSTRUCTION. DO NOT DRIVE OR STOCKPILE MATERIALS WITHIN THE DRIP LINE OF EXISTING TREES.

Ċ,

- REPAIR SITE: GRADE AND SEED SITE UPON COMPLETION. RESTORE ALL DISTURBED AREAS.
- CODES: ALL APPLICABLE LOCAL, STATE, AND FEDERAL REGULATIONS REGARDING BUT NOT LIMITED TO BUILDING, USE OF MATERIALS, DISPOSAL OF MATERIALS, AND SAFETY APPLY TO ALL ASPECTS OF THIS PROJECT. CONTRACTOR TO CARRY PERMITS IN BASE BID.
- PERMIT: CARRY PERMIT IN BASE BID.

6

Ņ

4.

HEAT & AIR CONDITIONING: DESIGN/BUILD. 2 ZONES: FIRST FLOOR AND SECOND FLOOR, PROVIDE 7 DAY PROGRAMMABLE THERMOSTATS. LAYOUT DRAWING SUBMITTAL REQUIRED FROVER BY ARCHITECT PRIOR TO INSTALLATION. PROVIDE POURED CONCRETE PAD FOR AC EQUIPMENT ON SITE — LOCATE WITH ARCHITECT AND OWNER IN FIELD. CONCEAL AC LINES WITHIN WALLS; DON'T LEAVE EXPOSED ON EXTERIOR OF HOUSE.

S TRU \bigcirc TU ∇ \triangleright \Box Z 0 \vdash I

S

ALL STRUCTURAL WORK TO WITH THE MASSACHUSETTS BE CARRIED OUT BUILDING CODE. IN ACCORDANCE

- FOUNDATION

 1. PROVIDE MINIMUM 4'-0" FROST COVER FOR FOOTINGS.

 2. ALLOWABLE SOIL BEARING ASSUMED TO BE 2,000 PSF.
 THIS IS TO BE CONFIRMED BY A GEOTECHNICAL ENGINEER PRIOR TO POURING FOOTINGS.

- CONCRETE

 CONCRETE 28 DAYS COMPRESSIVE STRENGTH TO BE

 CONCRETE STEEL REINFORCING TO BE ASTM A615 GRADE

 CONCRETE STEEL REINFORCING TO BE ASTM A615 GRADE

 60. WELDED WIRE MESH TO BE ASTM A185 WITH

 ULTIMATE TENSILE STRENGTH OF 70,000 PSI.

 OVERLAP STEEL BARS BY 2'-0" MINIMUM WHEN SPLICING.

 RETURN BARS BY 1'-0" MINIMUM AROUND CORNERS.

 PROVIDE 3" COVER FOR REINFORCING FROM THE BOTTOM
 OF FOOTINGS AND 1 1/2" COVER FOR REINFORCING
 FROM THE FACE OF WALLS.

112 STOW STREET

ACTON, MA 01720

- WOOD CONSTRUCTION

 1. TIMBER TO BE SPF NO. 2 OR BETTER.

 2. PROVIDE SIMPSON JOIST HANGERS WHERE JOISTS ARE SUPPORTED BY BEAMS.

 3. UNLESS OTHERWISE NOTED, PROVIDE SIMPSON CONNECTORS AT COLUMN/BEAM AND BEAM/BEAM CONNECTIONS. DETAILS TO BE IN ACCORDANCE WITH MANUFACTURER'S INSTRUCTIONS.

 4. MAXIMUM MOISTURE CONTENT TO BE 19%.

Г I \mathbf{C} [I] Z D

DOOR MARK SEE DOOR SCHEDULE

 Θ

SEE WINDOW SCHEDULE

WALL ASSEMBLY SEE DETAILS

⊳

 \bigcirc

DAVID WHITNEY \cap


GILBERT RESIDENCE

49 LINDEN STREET ARLINGTON, MA 02476 781 643 0759

Notes & Legends

AS NOTED FILE:

DAVID WHITNEY AIA

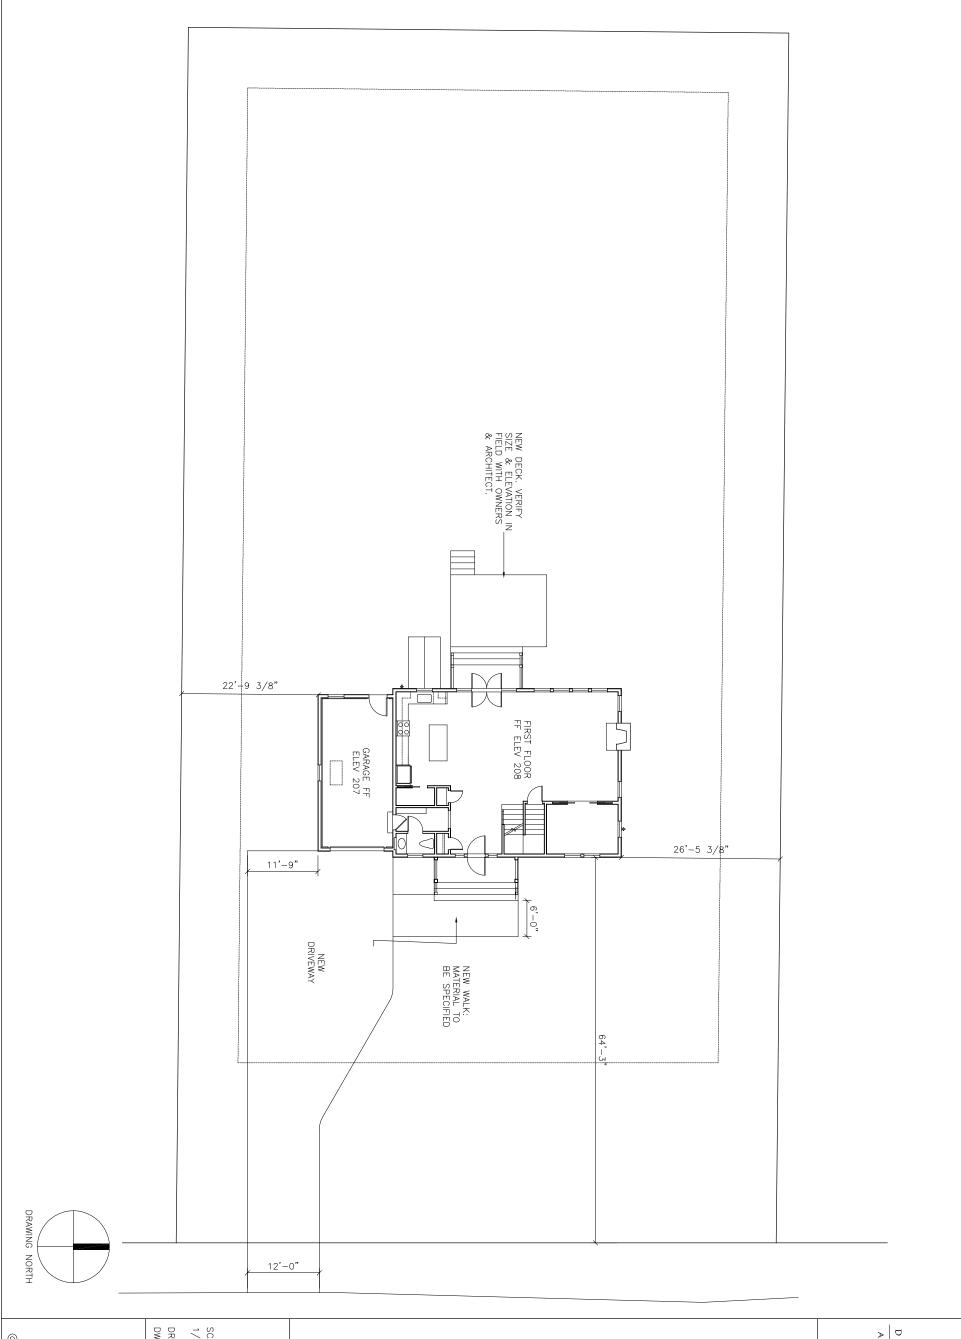


DAVID WHITNEY AIA

DRAWN BY: DWW Site Plan TITLE:

GILBERT RESIDENCE

112 STOW STREET ACTON, MA 01720

A R C H I T E C 49 LINDEN STREET ARLINGTON, MA 02476 781 643 0759

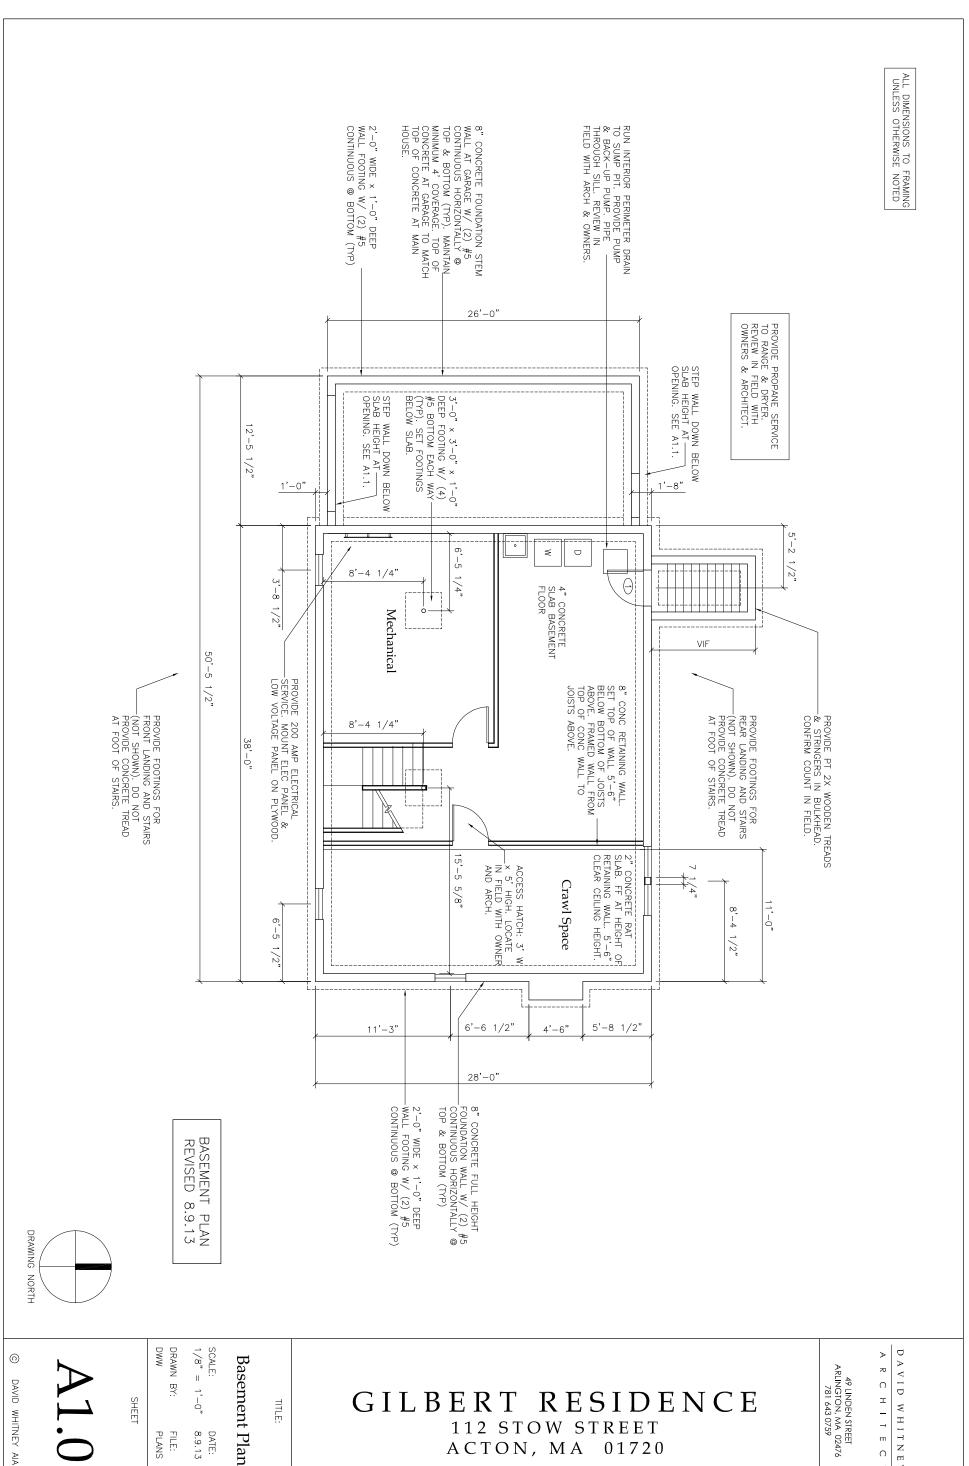

TITLE:


8.9.13 FILE PLANS


DAVID WHITNEY AIA

GILBERT RESIDENCE

112 STOW STREET ACTON, MA 01720 49 LINDEN STREET ARLINGTON, MA 02476 781 643 0759 R C H I T E

DAVID WHITNEY \cap

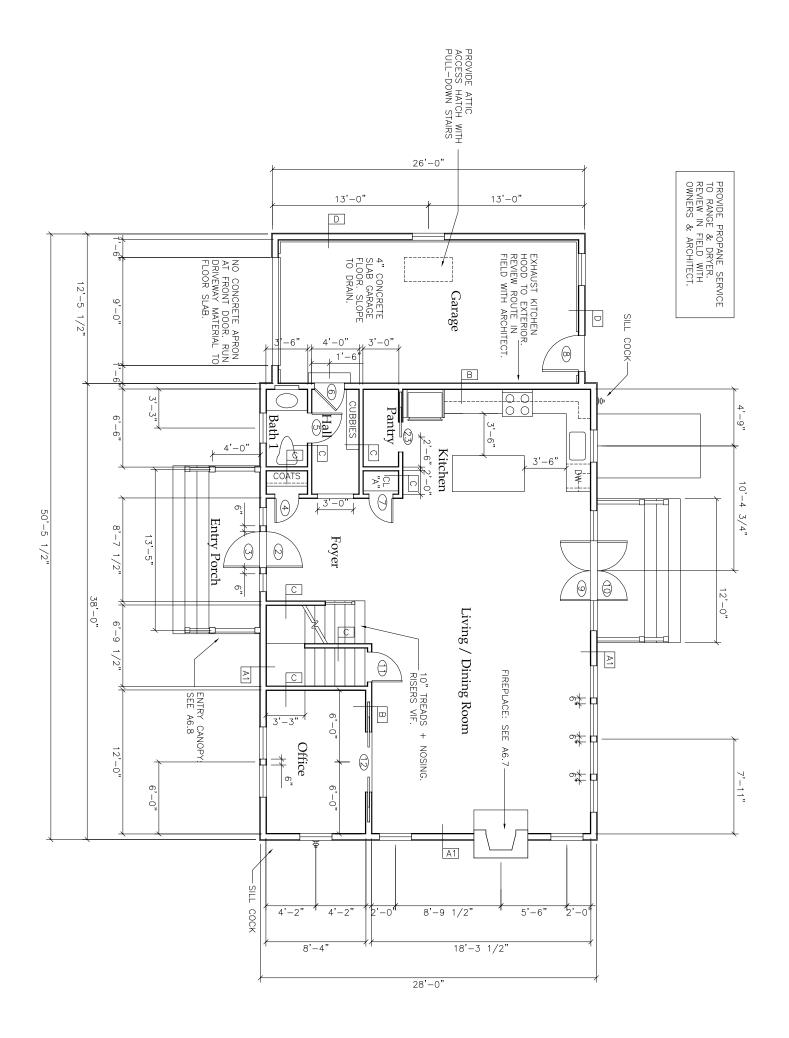

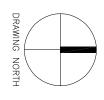

DAVID WHITNEY AIA


First Floor Plan


DRAWN BY:

GILBERT RESIDENCE

112 STOW STREET ACTON, MA 01720 49 LINDEN STREET ARLINGTON, MA 02476 781 643 0759

DAVID WHITNEY R C H I T E \cap

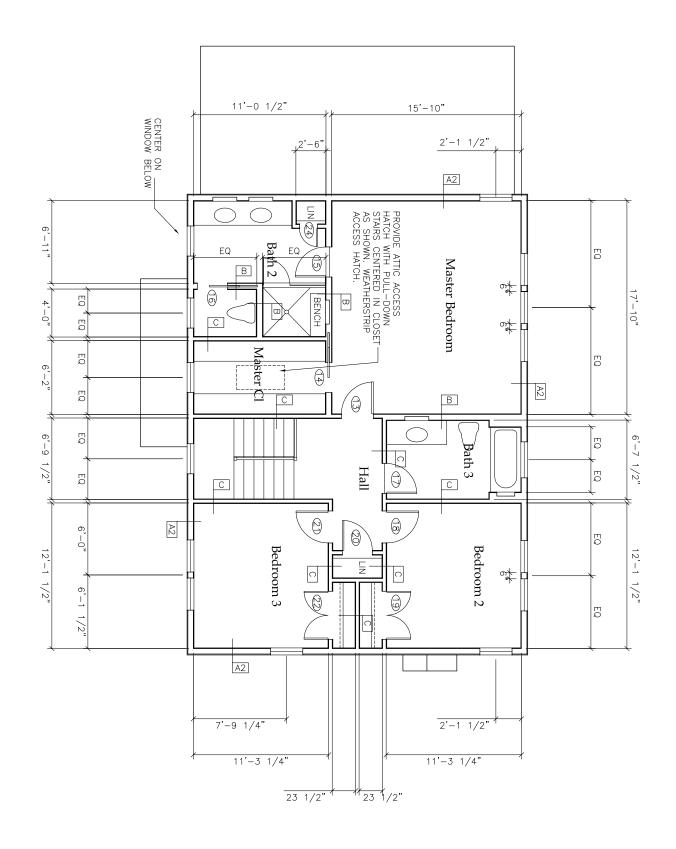

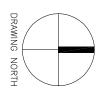

DAVID WHITNEY AIA

Second Floor Plan

DRAWN BY: DWW

GILBERT RESIDENCE

112 STOW STREET ACTON, MA 01720 49 LINDEN STREET ARLINGTON, MA 02476 781 643 0759 R C H I T E C

Roof Notes


- ROOF: ARCHITECTURAL 30 YEAR ASPHALT SHINGLE BY GAF OR APPROVED EQUAL. COLOR TO BE SPECIFIED.
- UNDERLAYMENT: PROVIDE GRACE ICE & WATER SHIELD UNDER ASPHALT SHINGLES OVER ENTIRE ROOFS, NOT JUST EAVES & VALLEYS.
- VENTS: NO RIDGE VENTS, NO EAVE VENTS. COLLECT PLUMBING VENTS IN ATTIC TO MINIMIZE ROOF PENETRATIONS. LOCATE IN FIELD WITH ARCHITECT.
- ATTIC: PROVIDE $3/4"\ \mbox{PLYWOOD}$ SUBFLOOR IN ENTIRE ATTIC, NOT JUST AN AREA UNDER RIDGES, FOR STORAGE.
- PROVIDE K-STYLE ALUMINUM GUTTERS & UNFLUTED ROUND DOWNSPOUTS. REVIEW IN FIELD WITH ARCHITECT. RUN BELOW GRADE IN PVC BOOTS. COLLECT IN DRYWELL LOCATE ON SITE WITH ARCHITECT & OWNERS.

ض.

4.

Ŋ

DOWNSPOUT AT SIDE OF HOUSE __ RUNS TO GARAGE GUTTER BELOW

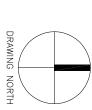

DOWNSPOUT AT SIDE OF HOUSE RUNS TO GARAGE GUTTER BELOW

SLOPE: 6" RISE IN 12" FRUN. NO GUTTERS AT FRONT CANOPY.

DOWNSPOUT AT SIDE OF HOUSE

SLOPE: 8" RISE IN 12" RUN

DAVID WHITNEY AIA

DRAWN BY: DWW


Roof Plan

TITLE:

GILBERT RESIDENCE 112 STOW STREET ACTON, MA 01720

49 LINDEN STREET ARLINGTON, MA 02476 781 643 0759 R C H I T E

DAVID WHITNEY \cap

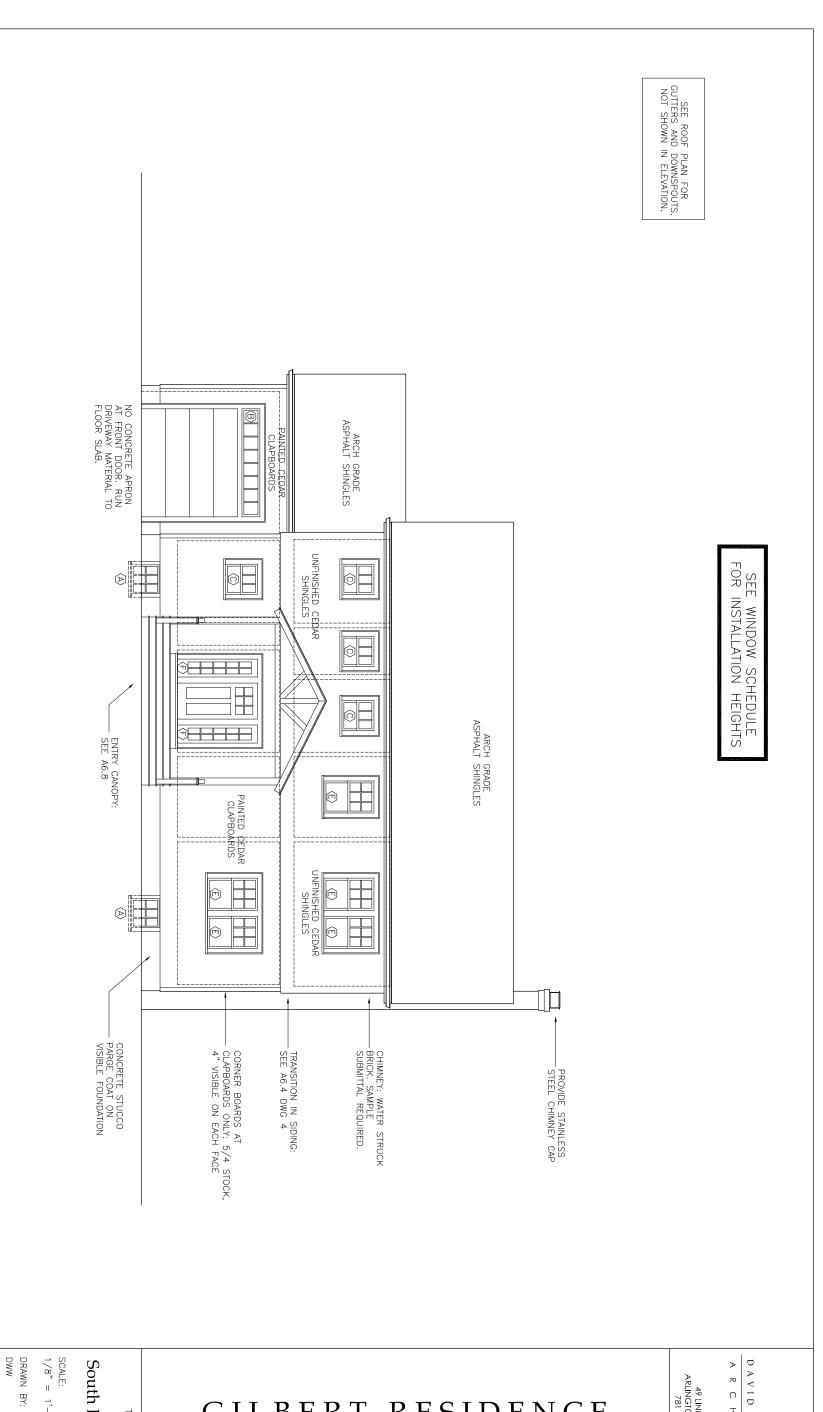

A2.1

DAVID WHITNEY AIA

South Elevation

DATE: 5.21.13 GILBERT RESIDENCE

112 STOW STREET ACTON, MA 01720

49 linden Street Arlington, ma 02476 781 643 0759

DAVID WHITNEY
ARCHITECT

SEE ROOF PLAN FOR GUTTERS AND DOWNSPOUTS. NOT SHOWN IN ELEVATION. BILCO METAL
BULKHEAD COVER, —
PAINTED. SEE A1.0. (G) PAINTED CEDAR CLAPBOARDS SEE WINDOW SCHEDULE FOR INSTALLATION HEIGHTS PAINTED CEDAR CLAPBOARDS \bigcirc CONCRETE STUCCO - PARGE COAT ON VISIBLE FOUNDATION NO CHANGE IN PLANE IN THIS WALL SET HEAD OF THIS -WINDOW ONLY 5'-4" ABOVE MAIN HOUSE FF ARCH GRADE ASPHALT SHINGLES ENTRY CANOPY: SEE A6.8 EXTERIOR STAIRS: 12"
TREADS + NOSING. CONFIRM
COUNT & RISER HEIGHT IN
FIELD WITH ARCH & OWNERS.

A2.2

DAVID WHITNEY AIA

DRAWN BY: DWW


West Elevation

GILBERT RESIDENCE

112 STOW STREET ACTON, MA 01720

49 LINDEN STREET
ARLINGTON, MA 02476
781 643 0759

DAVID WHITNEY
ARCHITECT

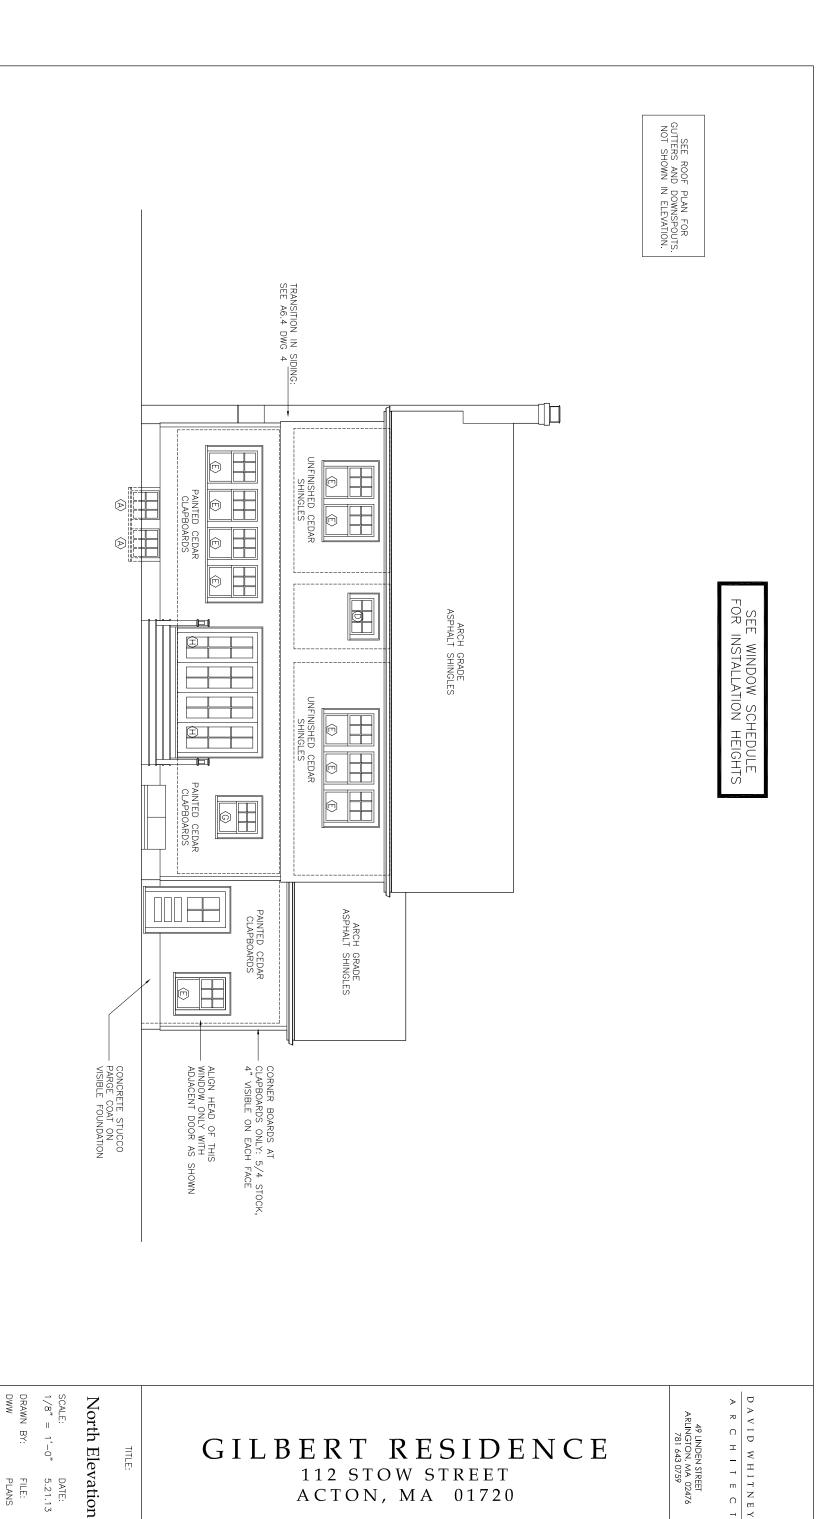

DAVID WHITNEY AIA

GILBERT RESIDENCE

112 STOW STREET ACTON, MA 01720 49 LINDEN STREET ARLINGTON, MA 02476 781 643 0759

DAVID WHITNEY R C H I T E C

SEE ROOF PLAN FOR GUTTERS AND DOWNSPOUTS. NOT SHOWN IN ELEVATION. ENTRY CANOPY: SEE A6.8 ARCH GRADE ASPHALT SHINGLES SEE WINDOW SCHEDULE FOR INSTALLATION HEIGHTS UNFINISHED CEDAR SHINGLES UNFINISHED CEDAR SHINGLES PAINTED CEDAR CLAPBOARDS (i) UNFINISHED CEDAR! CONCRETE STUCCO - PARGE COAT ON VISIBLE FOUNDATION CORNER BOARDS AT CLAPBOARDS ONLY: 5/4 STOCK, 4" VISIBLE ON EACH FACE TRANSITION IN SIDING: SEE A6.4 DWG 4 EXTERIOR STAIRS: 12"
TREADS + NOSING. CONFIRM
COUNT & RISER HEIGHT IN
FIELD WITH ARCH & OWNERS. LANDING & RAILINGS: SEE A6.3. DIE RAILINGS INTO SIDING.

A2.4

DAVID WHITNEY AIA

DRAWN BY: DWW

TITI F.

East Elevation


GILBERT RESIDENCE

112 STOW STREET ACTON, MA 01720 ARCHITEC

49 LINDEN STREET
ARLINGTON, MA 02476
781 643 0759

DAVID WHITNEY


A R C H I I E C I

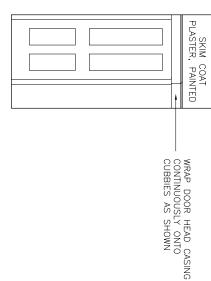

 $^{\prime}$ SCALE: 1/4" = 1'-0" First Floor Hall - West

 $\frac{2}{\text{SCALE: } 1/4" = 1'-0"}$


First Floor Hall - North

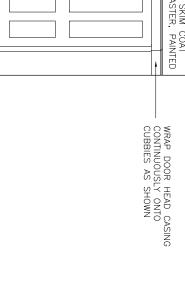

SKIM COAT PLASTER, PAINTED

CROWN: SEE FINISH SCHEDULE

OPEN TO FOYER

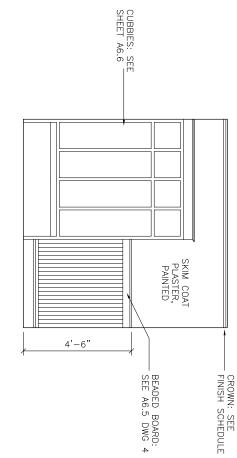

SKIM COAT PLASTER, PAINTED 4'-6"

4 SCALE: 1/4" = 1'-0" First Floor Hall - South

 $\frac{3}{\text{SCALE: }1/4" = 1'-0"}$

First Floor Hall - East

DAVID WHITNEY AIA

Interior Elevations First Fl Hall


TITLE:

SCALE: DATE: 1/4" = 1'-0" 5.21.13

FILE: PLANS

GILBERT RESIDENCE

112 STOW STREET ACTON, MA 01720 49 LINDEN STREET ARLINGTON, MA 02476 781 643 0759 R C H I T E C

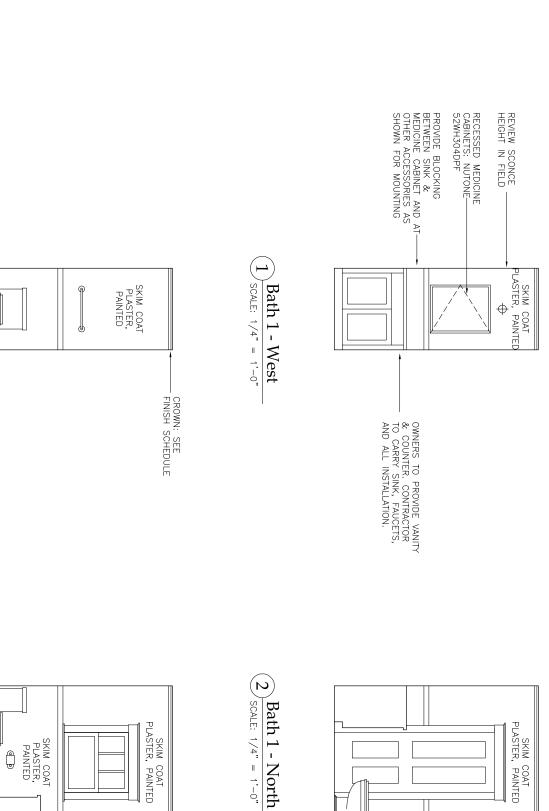




3) SCALE: 1/4" = 1'-0"

Bath 1 - East

OWNERS TO PROVIDE CABINETS, COUNTERTOPS, TILE, AND APPLIANCES. CONTRACTOR TO CARRY INSTALLATION IN BASE BID.

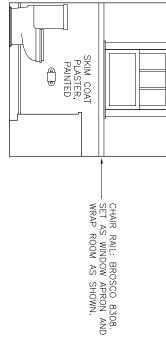

DRAWN BY:

FILE: PLANS

SHEET

SCALE: DATE: 1/4" = 1'-0" 5.21.13

Interior Elevations Bath 1

THE:

GILBERT RESIDENCE

112 STOW STREET ACTON, MA 01720 49 LINDEN STREET ARLINGTON, MA 02476 781 643 0759

CROWN: SEE FINISH SCHEDULE


DAVID WHITNEY R C H I T E C

DAVID WHITNEY AIA

3) Kit/Din/Liv Rm - North

 $\mathbb{D}\mathbb{W}$

ΞE

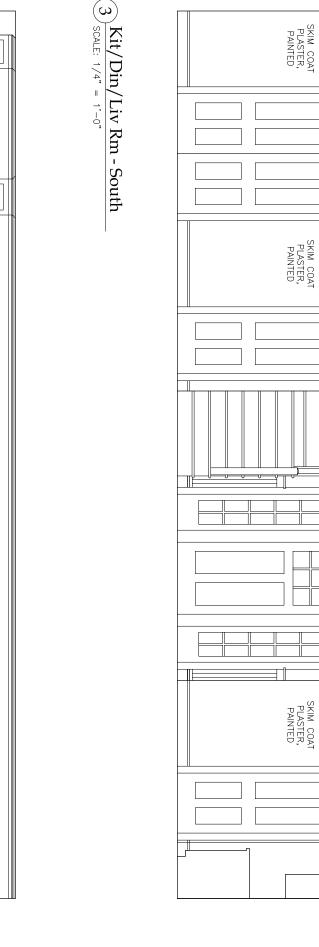

SHEET

FILE: PLANS

DAVID WHITNEY AIA

Interior Elevations Kit/Din/Liv Rm TITLE:

SCALE: DATE: 1/4" = 1'-0" 5.21.13

SKIM COAT PLASTER, PAINTED

GILBERT RESIDENCE

112 STOW STREET ACTON, MA 01720

ARCHITEC 49 LINDEN STREET ARLINGTON, MA 02476 781 643 0759

 $^{\prime}$ SCALE: 1/4" = 1'-0" Kit/Din/Liv Rm - West OPEN TO HALL FIREPLACE: SEE A6.7 SKIM COAT PLASTER, PAINTED FRIDGE RANGE HOOD SKIM COAT PLASTER, PAINTED

Kit/Din/Liv Rm - East

 $2 \frac{N11}{SCALE: 1/4" = 1'-0"}$

3) Island SCALE: 1/4" = 1'-0"

STAIR PARTS:

TREADS: OAK, STAINED & POLY'D.

RISERS: OAK, STAINED & POLY'D.

SCOTIA: BROSCO B-601, STAINED & POLY'D.

NEWELPOSTS: CROWN HERITAGE B-786, B-787, B-788, PAINTED.

HANDRAIL: CROWN HERITAGE 6010P, STAINED & POLY'D. NO ROSETTES.

BALUSTERS: CROWN HERITAGE 5060, PAINTED.

SHEET

Interior Elevations Kit/Din/Liv Rm TITLE:

SCALE: DATE: 1/4" = 1'-0" 5.21.13

FILE: PLANS

GILBERT RESIDENCE

CLOSED STRINGER/CURB: SEE A6.5 DWG 5

CROWN: SEE FINISH SCHEDULE

112 STOW STREET ACTON, MA 01720 49 LINDEN STREET ARLINGTON, MA 02476 781 643 0759 R C H I T E C DAVID WHITNEY


DAVID WHITNEY AIA

Office - East


SCALE: 1/4" = 1'-0"

Office - South

SCALE: 1/4" = 1'-0"

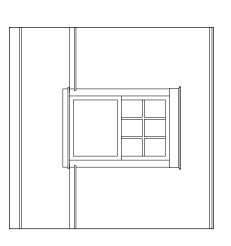


1) Office - West 1) SCALE: 1/4" = 1'-0"

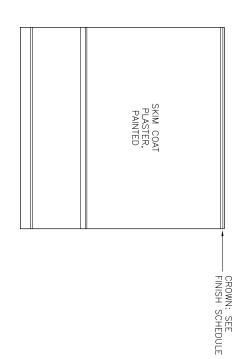

Office - North

Scale: 1/4" = 1'-0"

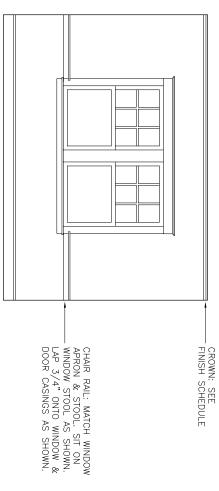

SKIM COAT
PLASTER,
PAINTED
SKIM COAT
PAINTED
SKIM COAT
PLASTER,
PAINTED

A4.15

DAVID WHITNEY AIA

Interior Elevations
Office

DRAWN BY:

FILE:

SHEET


SCALE: DATE: 1/4" = 1'-0" 5.21.13


GILBERT RESIDENCE
112 STOW STREET
ACTON, MA 01720

49 LINDEN STREET ARLINGTON, MA 02476 781 643 0759

DAVID WHITNEY


A R C H I T E C T

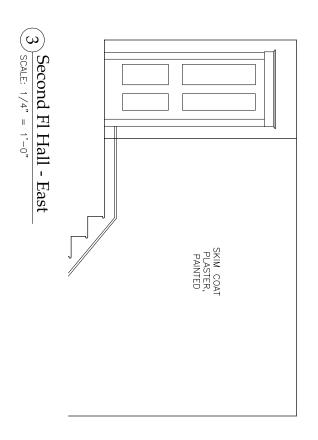

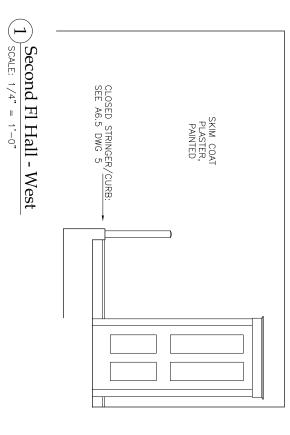

Second Fl Hall - North

SCALE: 1/4" = 1'-0"

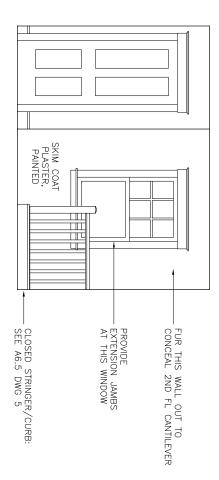

Interior Elevations

IIIE:


Second Fl Hall

DRAWN BY: DWW

FILE: PLANS

SHEET

SCALE: DATE: 1/4" = 1'-0" 5.21.13

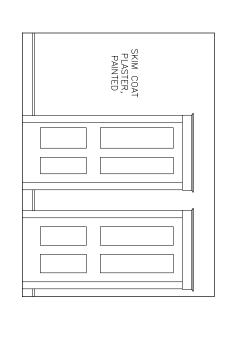

DAVID WHITNEY AIA

Second Fl Hall - South

SCALE: 1/4" = 1'-0"

GILBERT RESIDENCE

112 STOW STREET ACTON, MA 01720

ARCHITEC 49 LINDEN STREET ARLINGTON, MA 02476 781 643 0759

1) Master Bedroom - West SKIM COAT PLASTER, PAINTED SKIM COAT PLASTER, PAINTED CROWN: SEE FINISH SCHEDULE

Master Bedroom - East


Scale: 1/4" = 1'-0"

Master Bedroom - South

SCALE: 1/4" = 1'-0"

Master Bedroom - North

Scale: 1/4" = 1'-0"

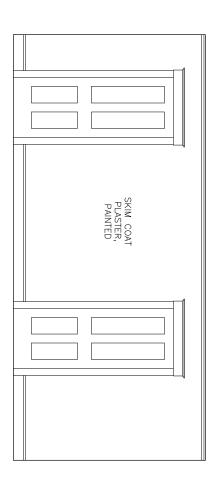

SKIM COAT PLASTER, PAINTED

CROWN: SEE FINISH SCHEDULE

Interior Elevations Master Bedroom

III LE:

SCALE: DATE: 1/4" = 1'-0" 5.21.13


FILE: PLANS

GILBERT RESIDENCE


112 STOW STREET ACTON, MA 01720

DAVID WHITNEY AIA


49 LINDEN STREET ARLINGTON, MA 02476 781 643 0759 R C H I T E C

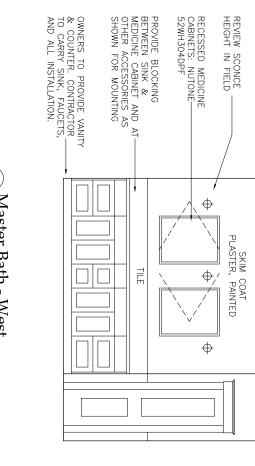

1) SCALE: 1/4" = 1'-0"Master Bath - West

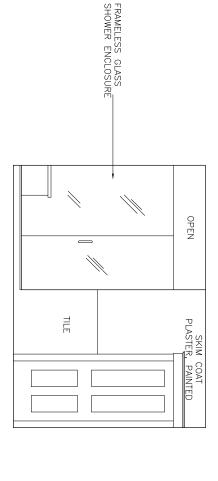

 $2)_{\text{SCALE: } 1/4" = 1'-0"}$ Master Bath - North

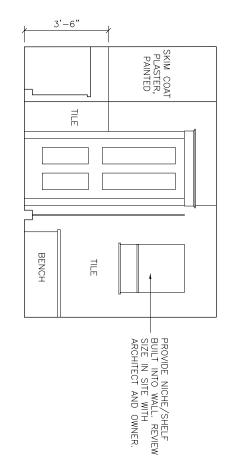

4 $\frac{1}{\text{SCALE: }1/4"} = 1'-0"$ Master Bath - South

 $\frac{3}{3} \frac{1 \times 1 \times 1}{3 \times 1} = \frac{1}{1} - 0$

Master Bath - East



Ē

Ē

Interior Elevations Master Bath

III LE:

SCALE: DATE: 1/4" = 1'-0" 5.21.13


FILE: PLANS


®


DAVID WHITNEY AIA


GILBERT RESIDENCE

112 STOW STREET ACTON, MA 01720 49 LINDEN STREET ARLINGTON, MA 02476 781 643 0759 R C H I T E C

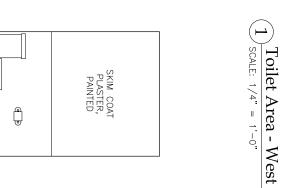

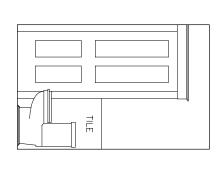

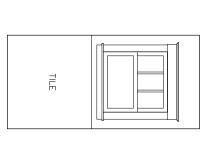

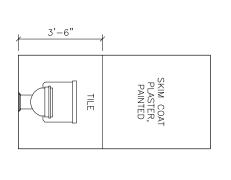

4 SCALE: 1/4" = 1'-0" Toilet Area - South

Toilet Area - East

SCALE: 1/4" = 1'-0"

DAVID WHITNEY AIA

Interior Elevations Master Bath

TITLE:

SCALE: DATE: 1/4" = 1'-0" 5.21.13

FILE: PLANS


GILBERT RESIDENCE


Toilet Area - North

SCALE: 1/4" = 1'-0"

112 STOW STREET ACTON, MA 01720

ARCHITEC 49 LINDEN STREET ARLINGTON, MA 02476 781 643 0759

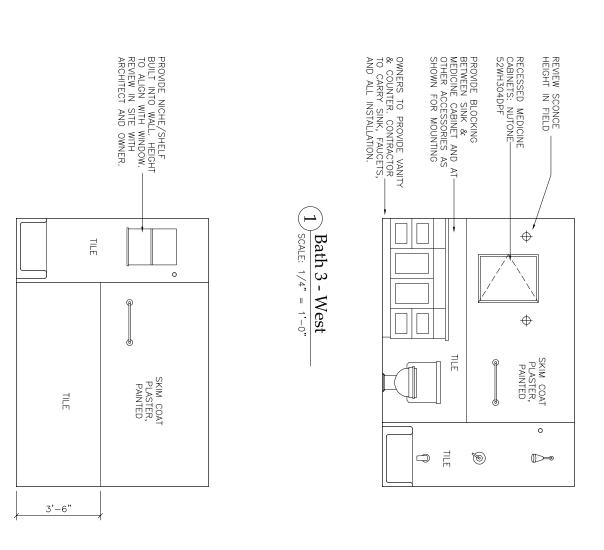

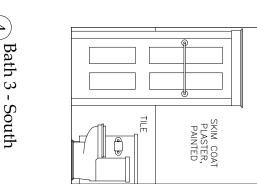


Interior Elevations

Bath 3

SCALE: DATE: 1/4" = 1'-0" 5.21.13

FILE: PLANS

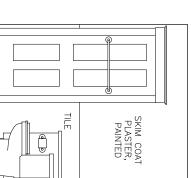

4 SCALE: 1/4" = 1'-0" Bath 3 - South

 $3) \frac{\nu_{\text{MM.}}}{\text{SCALE: } 1/4" = 1'-0"}$

Bath 3 - East

DAVID WHITNEY AIA

112 STOW STREET

 $\frac{1}{\text{SCALE: }1/4"} = 1'-0"$ Bath 3 - North

49 LINDEN STREET ARLINGTON, MA 02476 781 643 0759

PROVIDE FIXED STRAIGHT SHOWER CURTAIN ROD,____ FINISH TO MATCH PLUMBING FIXTURES

TILE

ΞLE

TILE


TUB

DAVID WHITNEY R C H I T E C


GILBERT RESIDENCE

ACTON, MA 01720




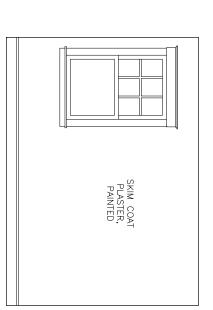

1) SCALE: 1/4" = 1'-0" Bedroom 2 - West

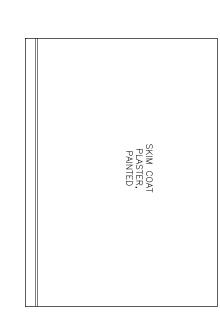


2 Bedroom 2 - North
SCALE: 1/4" = 1'-0"

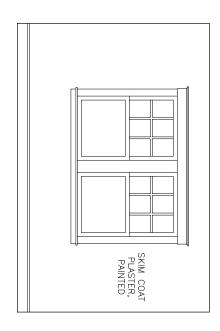

Bedroom 2 - South

SCALE: 1/4" = 1'-0"

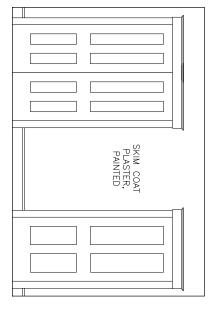

Interior Elevations Bedroom 2

TITLE:

SCALE: DATE: 1/4" = 1'-0" 5.21.13

FILE: PLANS

DAVID WHITNEY AIA


GILBERT RESIDENCE

112 STOW STREET ACTON, MA 01720

ARCHITEC 49 LINDEN STREET ARLINGTON, MA 02476 781 643 0759

Bedroom 3 - East

SCALE: 1/4" = 1'-0"

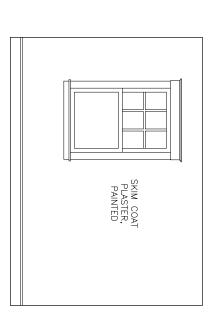

SKIM COAT PLASTER, PAINTED


Interior Elevations Bedroom 3

TITLE:


SCALE: DATE: 1/4" = 1'-0" 5.21.13

FILE: PLANS

1) SCALE: 1/4" = 1'-0" Bedroom 3 - West

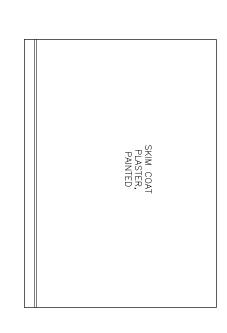

2 Bedroom 3 - North

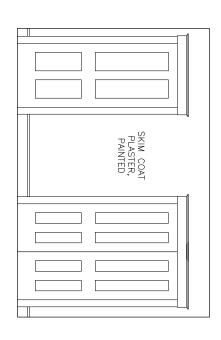

Bedroom 3 - South

SCALE: 1/4" = 1'-0"

DAVID WHITNEY AIA

GILBERT RESIDENCE

112 STOW STREET ACTON, MA 01720

ARCHITEC 49 LINDEN STREET ARLINGTON, MA 02476 781 643 0759

Finish Schedule

HALLWAY LINEN CLOSET	BEDROOM 3 CLOSET	BEDROOM 3	BEDROOM 2 CLOSET	BEDROOM 2	BATH 3	MASTER CLOSET	MASTER BATH LINEN CLOSET	MASTER BATH (BATH 2)	MASTER BEDROOM	SECOND FL HALL	STAIRS 1-TO-2	OFFICE	CLOSET A	PANTRY	KITCHEN / DIN / LIV RM	BATH 1	FIRST FL HALL	COAT CLOSET	FOYER	STAIRS B-TO-1	BASEMENT	GARAGE	ROOM NAME
OAK	OAK	OAK	OAK	OAK	TILE	OAK	TILE	TILE	OAK	OAK	OAK TREADS, STAINED	OAK, STAINED	OAK, STAINED	OAK, STAINED	OAK, STAINED	TILE	TILE	OAK, STAINED	OAK, STAINED	OAK TREADS	CONCRETE SLAB	CONCRETE SLAB	FLOOR
1/2" PLYWOOD OR MDO, PAINTED	SKIM COAT PLASTER, PAINTED	SKIM COAT PLASTER, PAINTED	SKIM COAT PLASTER, PAINTED	SKIM COAT PLASTER, PAINTED	SKIM COAT PLASTER / TILE. SEE INT ELEVS.	SKIM COAT PLASTER, PAINTED	1/2" PLYWOOD OR MDO, PAINTED	SKIM COAT PLASTER / TILE. SEE INT ELEVS.	SKIM COAT PLASTER, PAINTED	1/2" PLYWOOD OR MDO, PAINTED	1/2" PLYWOOD OR MDO, PAINTED	SKIM COAT PLASTER, PAINTED	SKIM COAT PLASTER, PAINTED	SKIM COAT PLASTER, PAINTED/ BEADED BOARD	SKIM COAT PLASTER, PAINTED	SKIM COAT PLASTER, PAINTED/ BEADED BOARD	SKIM COAT PLASTER, PAINTED	UNFINISHED CONCRETE	FIRE CODE X GWB, PAINTED	WALLS			
SKIM COAT PLASTER, PAINTED	SKIM COAT PLASTER, PAINTED	UNFINISHED	FIRE CODE X GWB, PAINTED	CEILING
POPLAR 1x8	POPLAR 1x8	SEE A6.5 DWG 3	POPLAR 1x8	SEE A6.5 DWG 3	TILE	SEE A6.5 DWG 3	TILE	TILE	SEE A6.5 DWG 3	POPLAR 1x8	POPLAR 1x8	SEE A6.5 DWG 3	SEE A6.5 DWG 3	SEE A6.5 DWG 3 & 4	POPLAR 1x8	SEE A6.5 DWG 3 & 4	1× APRON	1x8 AT FRAMED WALLS ONLY	1x4 ON TOP OF CONCRETE	WALL BASE			
POPLAR 1x4s	POPLAR 1x4s	SEE A6.5 DWG 1	POPLAR 1x4s	SEE A6.5 DWG 1	SEE A6.5 DWG 1	SEE A6.5 DWG 1	POPLAR 1x4s	SEE A6.5 DWG 1	SEE A6.5 DWG 1	SEE A6.5 DWG 1	SEE A6.5 DWG 1	SEE A6.5 DWG 1	POPLAR 1x4s	POPLAR 1x4s	SEE A6.5 DWG 1	SEE A6.5 DWG 1	SEE A6.5 DWG 1	POPLAR 1x4s	SEE A6.5 DWG 1	POPLAR 1x4s	POPLAR 1x4s	POPLAR 1x4s	CASINGS
NONE	NONE	NONE	NONE	NONE	NONE	NONE	NONE	NONE	BROSCO 8288	NONE	NONE	BROSCO 8288	NONE	NONE		BROSCO 8288	BROSCO 8288	NONE		NONE	NONE	NONE	CROWN
PAINTED	PAINTED	PAINTED	PAINTED	PAINTED	PAINTED	PAINTED	PAINTED	PAINTED	PAINTED	PAINTED	PAINTED	PAINTED	PAINTED	PAINTED	PAINTED	PAINTED	PAINTED	PAINTED	PAINTED	PAINTED	PAINTED	PAINTED	TRIM FINISH
ADJ SHELVES: SEE A6.4 DWG 3	SHELF & ROD: SEE A6.4 DWG 2		SHELF & ROD: SEE A6.4 DWG 2				ADJ SHELVES: SEE A6.4 DWG 3					CHAIR RAIL: SEE INT ELEVS	ADJ SHELVES: SEE A6.4 DWG 3			CHAIR RAIL: SEE INT ELEVS	CUBBIES: SEE A6.6	SHELF & ROD: SEE A6.4 DWG 2					NOTES
R 2 T	S	Т (C	W	S	T	R I	ΕE	ΞT	1	1	J	C						781 643 0759	ARLINGTON, MA 02476		A R C H I T E C I	DAVID WHITNEY

FINISH NOTES

- 1. WALL BOARD: USE 5/8" WALL BOARD ON CEILINGS. 1/2" WALL BOARD IS ACCEPTABLE ON WALLS.
- 2. PLASTER: ALL PLASTER EVERYWHERE IN AREA OF WORK TO BE SMOOTH, INCLUDING CLOSETS, CEILINGS, AND CLOSET CEILINGS.
- 3. TILE & STONE: ALL TILE & STONE TO BE DETERMINED. CARRY INSTALLATION IN BASE BID. PROVIDE WONDERBOARD OR APPROVED SUBSTITUTE BACKER BOARD AT ALL TILE LOCATIONS, WALLS AND FLOORS.
- 4. THRESHOLDS: REVIEW INTERIOR THRESHOLDS IN FIELD WITH ARCHITECT PRIOR TO INSTALLING FLOORING.

Finish Schedule

SCALE: AS NOTED

DRAWN BY:

FILE: PLANS

GILBERT RESIDENCE 112 STOW STREET ACTON, MA 01720

DAVID WHITNEY AIA

Door Schedule

HEIGHT WIDTH THICKNESS MANF MODEL	NUMBER	SIZE			DOOR			HW	STOP	NOTES
6' - 8" 3' - 0" 1 3/4" FLUSH FIBERCLAS 6' - 8" 3' - 0" 1 3/4" SIMPSON 6' - 8" 2' - 0" 1 3/8" SIMPSON 6' - 8" 2' - 6" 1 3/8" SIMPSON 6' - 8" 2' - 6" 1 3/8" SIMPSON 6' - 8" 2' - 0" 1 3/4" SIMPSON 6' - 8" 2' - 0" 1 3/4" SIMPSON 6' - 8" 2' - 0" 1 3/4" SIMPSON 6' - 8" 1 3/ - 0" 1 3/4" SIMPSON 6' - 8" 2' - 6" 1 3/8" SIMPSON 6' - 8" 2' - 6" 1 3/8" SIMPSON 6' - 8" 2' - 6" 1 3/8" SIMPSON 6' - 8" 1 3/8" SIMPSON		HEIGHT	WIDTH	THICKNESS	MANF	MODEL	FINISH			
6' - 8" 3' - 0" 1 3/4" SIMPSON 6' - 8" 2' - 0" 1 1/8" SIMPSON 6' - 8" 2' - 6" 1 3/8" SIMPSON 6' - 8" 2' - 6" 1 3/8" SIMPSON 6' - 8" 2' - 6" 1 3/8" SIMPSON 6' - 8" 2' - 6" 1 3/4" SIMPSON 6' - 8" 2' - 6" 1 3/4" SIMPSON 6' - 8" 2' - 6" 1 3/4" SIMPSON 6' - 8" 2' - 6" 1 3/4" SIMPSON 6' - 8" 1 3/4" SIMPSON 6' - 8" 1 3/8" SIMPSON 6' - 8" 2' - 6" 1 3/8" SIMPSON 6' - 8" 2' - 6" 1 3/8" SIMPSON 6' - 8" 1 3/8" SIMPSON		1	1	1 3/4"	FLUSH FIBERGL	ASS	NONE	EXTERIOR	NONE	ALUMINUM THRESHOLD
6' - 8" 2' - 0" 1 1/8" SIMPSON 6' - 8" 2' - 6" 1 3/8" SIMPSON 6' - 8" 2' - 6" 1 3/8" SIMPSON 6' - 8" 2' - 6" 1 3/4" SIMPSON 6' - 8" 2' - 6" 1 3/4" SIMPSON 6' - 8" 2' - 6" 1 3/4" SIMPSON 6' - 8" 5' - 0" 1 3/4" SIMPSON 6' - 8" 5' - 0" 1 3/4" SIMPSON 6' - 8" 5' - 0" 1 3/4" SIMPSON 6' - 8" 5' - 0" 1 3/8" SIMPSON 6' - 8" 5' - 0" 1 3/8" SIMPSON 6' - 8" 2' - 6" 1 3/8" SIMPSON 6' - 8" 2' - 6" 1 3/8" SIMPSON 6' - 8" 2' - 6" 1 3/8" SIMPSON 6' - 8" 2' - 6" 1 3/8" SIMPSON 6' - 8" SIMPSON 6' - 8" 1 3/8" SIMPSON 6' - 8" SIMPSON 6' - 8" 1 3/8" SIMPSON 6' - 8" SIMPSON 6' -	2		1	1 3/4"	SIMPSON	F-7662	PAINTED	ENTRY	FLOOR	OAK THRESHOLD
6' - 8" 2' - 0" 1 3/8" SIMPSON 6' - 8" 2' - 6" 1 3/8" SIMPSON 6' - 8" 2' - 6" 1 3/4" SIMPSON 6' - 8" 2' - 0" 1 3/4" SIMPSON 6' - 8" 5' - 0" 1 3/4" SIMPSON 6' - 8" 5' - 0" 1 3/4" SIMPSON 6' - 8" 2' - 6" 1 3/8" SIMPSON 6' - 8" 2' - 6" 1 3/8" SIMPSON 6' - 8" 2' - 6" 1 3/8" SIMPSON 6' - 8" 2' - 6" 1 3/8" SIMPSON 6' - 8" 2' - 6" 1 3/8" SIMPSON 6' - 8" SIMPSON	3	1	1	1 1/8"		ULTRA-VU	PAINTED	SCREEN	NONE	1 LITE STORM PANEL
6° - 8" 2° - 6" 1 3/8" SIMPSON 44 6° - 8" 2° - 6" 1 3/4" SIMPSON 44 6° - 8" 2° - 0" 1 3/4" SIMPSON 44 6° - 8" 2° - 0" 1 3/4" SIMPSON 710 6° - 8" 5° - 0" 1 3/4" SIMPSON 710 6° - 8" 2° - 6" 1 3/8" SIMPSON 710 6° - 8" 2° - 6" 1 3/8" SIMPSON 710 6° - 8" 2° - 6" 1 3/8" SIMPSON 44 6° - 8" 2° - 6" 1 3/8" SIMPSON 44 6° - 8" 2° - 6" 1 3/8" SIMPSON 44 6° - 8" 2° - 6" 1 3/8" SIMPSON 44 6° - 8" 2° - 6" 1 3/8" SIMPSON 44 6° - 8" 2° - 6" 1 3/8" SIMPSON 44 6° - 8" 2° - 6" 1 3/8" SIMPSON 44 6° - 8" 2° - 6" 1 3/8" SIMPSON 44 6° - 8" 2° - 6" 1 3/8" SIMPSON	4	ī	ī	1 3/8"	SIMPSON	44 PAINT GRADE	PAINTED	PASSAGE	WALL	
6' - 8" 2' - 6" 1 3/4" SIMPSON 44 6' - 8" 2' - 0" 1 3/8" SIMPSON 44 6' - 8" 3' - 0" 1 3/4" SIMPSON 710 6' - 8" 5' - 0" 1 3/4" SIMPSON 710 6' - 8" 5' - 0" 1 3/8" SIMPSON 710 6' - 8" 2' - 6" 1 3/8" SIMPSON 44 6' - 8" 2' - 6" 1 3/8" SIMPSON 44 6' - 8" 2' - 6" 1 3/8" SIMPSON 44 6' - 8" 2' - 6" 1 3/8" SIMPSON 44 6' - 8" 2' - 6" 1 3/8" SIMPSON 44 6' - 8" 2' - 6" 1 3/8" SIMPSON 44 6' - 8" 2' - 6" 1 3/8" SIMPSON 44 6' - 8" 2' - 6" 1 3/8" SIMPSON 44 6' - 8" 2' - 6" 1 3/8" SIMPSON 44 6' - 8" 2' - 6" 1 3/8" SIMPSON 44 6' - 8" 1 3/8" SIMPSON 44 <t< td=""><td>5</td><td>i</td><td>i</td><td>1 3/8"</td><td>SIMPSON</td><td>44 PAINT GRADE</td><td>PAINTED</td><td>BATH</td><td>NONE</td><td>OUTSWING</td></t<>	5	i	i	1 3/8"	SIMPSON	44 PAINT GRADE	PAINTED	BATH	NONE	OUTSWING
6' - 8" 2' - 0" 1 3/8" SIMPSON 44 6' - 8" 3' - 0" 1 3/4" SIMPSON F-4 6' - 8" 5' - 0" 1 3/4" SIMPSON 710 6' - 8" 5' - 0" 1 1/8" SIMPSON 710 6' - 8" 2' - 6" 1 3/8" SIMPSON 44 6' - 8" 2' - 6" 1 3/8" SIMPSON 44 6' - 8" 2' - 6" 1 3/8" SIMPSON 44 6' - 8" 2' - 6" 1 3/8" SIMPSON 44 6' - 8" 2' - 6" 1 3/8" SIMPSON 44 6' - 8" 2' - 6" 1 3/8" SIMPSON 44 6' - 8" 2' - 6" 1 3/8" SIMPSON 44 6' - 8" 2' - 6" 1 3/8" SIMPSON 44 6' - 8" 2' - 6" 1 3/8" SIMPSON 44 6' - 8" 2' - 6" 1 3/8" SIMPSON 44 6' - 8" 2' - 6" 1 3/8" SIMPSON 44 6' - 8" 4' - 0" 1 3/8" SIMPSON 4	6	1		- 1	SIMPSON	44 PAINT GRADE	PAINTED	EXTERIOR	WALL	OAK THRESH., RATED DR
6' - 8" 3' - 0" 1 3/4" SIMPSON F	7	1	1	1 3/8"	SIMPSON	44 PAINT GRADE	PAINTED	PASSAGE	NONE	
6' - 8" 5' - 0" 1 3/4" SIMPSON 710 6' - 8" 5' - 0" 1 1/8" COMB DR CO UL1 6' - 8" 2' - 6" 1 3/8" SIMPSON 44 6' - 8" 2' - 6" 1 3/8" SIMPSON 44 6' - 8" 2' - 6" 1 3/8" SIMPSON 44 6' - 8" 2' - 6" 1 3/8" SIMPSON 44 6' - 8" 2' - 6" 1 3/8" SIMPSON 44 6' - 8" 2' - 6" 1 3/8" SIMPSON 44 6' - 8" 2' - 6" 1 3/8" SIMPSON 44 6' - 8" 2' - 6" 1 3/8" SIMPSON 44 6' - 8" 2' - 6" 1 3/8" SIMPSON 44 6' - 8" 2' - 6" 1 3/8" SIMPSON 44 6' - 8" 2' - 6" 1 3/8" SIMPSON 44 6' - 8" 2' - 6" 1 3/8" SIMPSON 44 6' - 8" 2' - 6" 1 3/8" SIMPSON 44 6' - 8" 4' - 0" 1 3/8" SIMPSON <td< td=""><td>00</td><td>Ι</td><td>1</td><td>1 3/4"</td><td>SIMPSON</td><td>F-418</td><td>PAINTED</td><td>EXTERIOR</td><td>WALL</td><td>ALUMINUM THRESHOLD</td></td<>	00	Ι	1	1 3/4"	SIMPSON	F-418	PAINTED	EXTERIOR	WALL	ALUMINUM THRESHOLD
6' - 8" 5' - 0" 1 1/8" COMB DR CO ULI 6' - 8" 2' - 6" 1 3/8" SIMPSON 44 6' - 8" 2' - 6" 1 3/8" SIMPSON 44 6' - 8" 2' - 6" 1 3/8" SIMPSON 44 6' - 8" 2' - 6" 1 3/8" SIMPSON 44 6' - 8" 2' - 6" 1 3/8" SIMPSON 44 6' - 8" 2' - 6" 1 3/8" SIMPSON 44 6' - 8" 2' - 6" 1 3/8" SIMPSON 44 6' - 8" 2' - 6" 1 3/8" SIMPSON 44 6' - 8" 2' - 6" 1 3/8" SIMPSON 44 6' - 8" 2' - 6" 1 3/8" SIMPSON 44 6' - 8" 2' - 6" 1 3/8" SIMPSON 44 6' - 8" 2' - 6" 1 3/8" SIMPSON 44 6' - 8" 4' - 0" 1 3/8" SIMPSON 44 6' - 8" 4' - 0" 1 3/8" SIMPSON 44 6' - 8" 4' - 0" 1 3/8" SIMPSON	9	1	ı	1 3/4"	SIMPSON	7106	PAINTED	DBL EXTERIOR	2 WALL	OAK THRESHOLD
6' - 8" 2' - 6" 1 3/8" SIMPSON 44 6' - 8" 2' - 6" 1 3/8" SIMPSON 44 6' - 8" 2' - 8" 1 3/8" SIMPSON 44 6' - 8" 2' - 6" 1 3/8" SIMPSON 44 6' - 8" 2' - 6" 1 3/8" SIMPSON 44 6' - 8" 2' - 6" 1 3/8" SIMPSON 44 6' - 8" 2' - 6" 1 3/8" SIMPSON 44 6' - 8" 2' - 6" 1 3/8" SIMPSON 44 6' - 8" 2' - 8" 1 3/8" SIMPSON 44 6' - 8" 2' - 8" 1 3/8" SIMPSON 44 6' - 8" 1 3/8" SIMPSON 44	10	1	1	1 1/8"	DR	ULTRA-VU	PAINTED	DBL SCREEN	NONE	1 LITE STORM PANELS
6' - 8" 5' - 0" 1 3/8" SIMPSON 44 6' - 8" 2' - 8" 1 3/8" SIMPSON 44 6' - 8" 2' - 6" 1 3/8" SIMPSON 44 6' - 8" 2' - 6" 1 3/8" SIMPSON 44 6' - 8" 2' - 6" 1 3/8" SIMPSON 44 6' - 8" 2' - 6" 1 3/8" SIMPSON 44 6' - 8" 2' - 6" 1 3/8" SIMPSON 44 6' - 8" 2' - 6" 1 3/8" SIMPSON 44 6' - 8" 2' - 6" 1 3/8" SIMPSON 44 6' - 8" 4' - 0" 1 3/8" SIMPSON 44 6' - 8" 4' - 0" 1 3/8" SIMPSON 44 6' - 8" 4' - 0" 1 3/8" SIMPSON 44	11	Ι	Ι	1 3/8"	SIMPSON	44 PAINT GRADE	PAINTED	PASSAGE	NONE	
6' - 8" 2' - 6" 1 3/8" SIMPSON 44 6' - 8" 2' - 6" 1 3/8" SIMPSON 44 6' - 8" 2' - 6" 1 3/8" SIMPSON 44 6' - 8" 2' - 6" 1 3/8" SIMPSON 44 6' - 8" 2' - 6" 1 3/8" SIMPSON 44 6' - 8" 2' - 6" 1 3/8" SIMPSON 44 6' - 8" 2' - 6" 1 3/8" SIMPSON 44 6' - 8" 4' - 0" 1 3/8" SIMPSON 44 6' - 8" 2' - 6" 1 3/8" SIMPSON 44 6' - 8" 1 3/8" SIMPSON 44	12	1	1	1 3/8"	SIMPSON	44 PAINT GRADE	PAINTED	DBL POCKET	NONE	SEE A6.5 DWG 2
6' - 8" 2' - 6" 1 3/8" SIMPSON 44 6' - 8" 2' - 6" 1 3/8" SIMPSON 44 6' - 8" 2' - 6" 1 3/8" SIMPSON 44 6' - 8" 2' - 6" 1 3/8" SIMPSON 44 6' - 8" 2' - 6" 1 3/8" SIMPSON 44 6' - 8" 4' - 0" 1 3/8" SIMPSON 44 6' - 8" 2' - 6" 1 3/8" SIMPSON 44 6' - 8" 1 3/8" SIMPSON 44 6' - 8" 1 3/8" SIMPSON 44 44 44 6' - 8" 4' - 0" 1 3/8" SIMPSON 44 44 44 44 44 45 44	13	1	Ι	1 3/8"	SIMPSON	44 PAINT GRADE	PAINTED	PRIVACY	WALL	
6' - 8" 2' - 6" 1 3/8" SIMPSON 44 6' - 8" 2' - 6" 1 3/8" SIMPSON 44 6' - 8" 2' - 6" 1 3/8" SIMPSON 44 6' - 8" 2' - 6" 1 3/8" SIMPSON 44 6' - 8" 2' - 6" 1 3/8" SIMPSON 44 6' - 8" 2' - 6" 1 3/8" SIMPSON 44 6' - 8" 2' - 6" 1 3/8" SIMPSON 44 6' - 8" 1 3/8" SIMPSON 44 6' - 8" 1 3/8" SIMPSON 44 44 44 6' - 8" 4' - 0" 1 3/8" SIMPSON 44 44 44 44 44	14	Ι	Ι	1 3/8"	SIMPSON	44 PAINT GRADE	PAINTED	POCKET	NONE	SEE A6.5 DWG 2
6' - 8" 2' - 0" 1 3/8" SIMPSON 44 6' - 8" 2' - 6" 1 3/8" SIMPSON 44 6' - 8" 2' - 6" 1 3/8" SIMPSON 44 6' - 8" 2' - 6" 1 3/8" SIMPSON 44 6' - 8" 2' - 6" 1 3/8" SIMPSON 44 6' - 8" 2' - 6" 1 3/8" SIMPSON 44 6' - 8" 2' - 6" 1 3/8" SIMPSON 44 6' - 8" 1 3/8" SIMPSON 44 6' - 8" 4' - 0" 1 3/8" SIMPSON 44 6' - 8" 4' - 0" 1 3/8" SIMPSON 44 6' - 8" 5' - 6" 1 3/8" SIMPSON 44	15	1	1	1 3/8"	SIMPSON	44 PAINT GRADE	PAINTED	ВАТН	FLOOR	
6' - 8" 2' - 6" 1 3/8" SIMPSON 44 6' - 8" 2' - 8" 1 3/8" SIMPSON 44 6' - 8" 4' - 0" 1 3/8" SIMPSON 44 6' - 8" 2' - 6" 1 3/8" SIMPSON 44 6' - 8" 2' - 6" 1 3/8" SIMPSON 44 6' - 8" 2' - 6" 1 3/8" SIMPSON 44 6' - 8" 1' - 6" 1 3/8" SIMPSON 44 6' - 8" 4' - 0" 1 3/8" SIMPSON 44 6' - 8" 4' - 0" 1 3/8" SIMPSON 44	16	1	1		SIMPSON	44 PAINT GRADE	PAINTED	BATH POCKET	NONE	SEE A6.5 DWG 2
6' - 8" 2' - 8" 1 3/8" SIMPSON 44 6' - 8" 2' - 6" 1 3/8" SIMPSON 44 6' - 8" 2' - 6" 1 3/8" SIMPSON 44 6' - 8" 2' - 6" 1 3/8" SIMPSON 44 6' - 8" 1 3/8" SIMPSON 44 6' - 8" 1 3/8" SIMPSON 44 6' - 8" 1 3/8" SIMPSON 44 44 44	17	Ι	Ι	1 3/8"	SIMPSON	44 PAINT GRADE	PAINTED	ВАТН	WALL	
6' - 8" 4' - 0" 1 3/8" SIMPSON 44 6' - 8" 2' - 6" 1 3/8" SIMPSON 44 6' - 8" 2' - 6" 1 3/8" SIMPSON 44 6' - 8" 2' - 6" 1 3/8" SIMPSON 44 6' - 8" 1' - 6" 1 3/8" SIMPSON 44 44 44	18	ı	Ι	1 3/8"	SIMPSON	44 PAINT GRADE	PAINTED	PRIVACY	WALL	
6' - 8" 2' - 6" 1 3/8" SIMPSON 44 6' - 8" 2' - 6" 1 3/8" SIMPSON 44 6' - 8" 4' - 0" 1 3/8" SIMPSON 44 6' - 8" 1' - 6" 1 3/8" SIMPSON 44 44 44 44	19	ı	1	1 3/8"	SIMPSON	44 PAINT GRADE	PAINTED	DBL CLOSET	2 WALL	
6' - 8" 2' - 8" 1 3/8" SIMPSON 44 6' - 8" 2' - 6" 1 3/8" SIMPSON 44 6' - 8" 1' - 6" 1 3/8" SIMPSON 44	20	1	1	1 3/8"	SIMPSON	44 PAINT GRADE	PAINTED	PASSAGE	FLOOR	
6' - 8" 4' - 0" 1 3/8" SIMPSON 44 6' - 8" 2' - 6" 1 3/8" SIMPSON 44	21	1	Ι	1 3/8"	SIMPSON	44 PAINT GRADE	PAINTED	PRIVACY	WALL	
6' - 8" 2' - 6" 1 3/8" SIMPSON 44 1' - 6" 1 3/8" SIMPSON 44	22	Ι	Ι	1 3/8"	SIMPSON	44 PAINT GRADE	PAINTED	DBL CLOSET	2 WALL	
6' - 8" 1' - 6" 1 3/8" SIMPSON 44	23	1	1	1 3/8"	SIMPSON	44 PAINT GRADE	PAINTED	POCKET	NONE	
	24	1		1 3/8"	SIMPSON	44 PAINT GRADE	PAINTED	BATH CL	NONE	

Door Hardware Schedule

EXTERIOR
HINGES: BALDWIN 1040, (3) PER LEAF, WITH BALDWIN 1090 BALL FINIALS.
LOCK SET: BALDWIN 5205 KEY-IN-KNOB SET.
ENSURE LATCH DOESN'T DAMAGE CASING. PROVIDE OVERSIZE STRIKE IF RE OVERSIZE STRIKE IF REQUIRED.

HINGES: BALDWIN 1040, (3) PER LEAF, WITH BALDWIN 1090 BALL FINIALS.
LOCK SET: BALDWIN 5205 KEY-IN-KNOB SET.
ENSURE LATCH DOESN'T DAMAGE CASING. PROVIDE OVERSIZE STRIKE IF REQUIRED.
DOUBLE DUMMY TRIM TO MATCH 5205 ON INACTIVE LEAF.
SURFACE BOLTS: BALDWIN 0321 AT TOP & BOTTOM OF INACTIVE LEAF.

ENTRY
HINGES: BALDWIN 1040, (3) PER LEAF, WITH BALDWIN 1090 BALL FINIALS.
LOCK SET: BALDWIN MADISON 5320 TUBULAR SET.
ENSURE LATCH DOESN'T DAMAGE CASING. PROVIDE OVERSIZE STRIKE IF REQUIRED.

$\overline{\text{ES:}}$ Standard hinges provided with door, mortise, do not surface mount.

LATCH SET: REJUVENATION LANE SCREEN DOOR SET INSTALL STANDARD CLOSER & CHAIN PROVIDED WITH #C3141. H DOOR.

DOUBLE SCREEN
HINGES: STANDARD HINGES PROVIDED WITH DOOR. MORTISE, DO NOT SURFACE MOUNT.

LATCH SET: REJUVENATION LANE SCREEN DOOR SET #C3141
INSTALL STANDARD CLOSER & CHAIN PROVIDED WITH DOOR ON BOTH LEAVES.
DOUBLE DUMMY TRIM TO MATCH ON INACTIVE LEAF.
SURFACE BOLTS: BALDWIN 0321 AT TOP & BOTTOM OF INACTIVE LEAF

HINGES: EMTEK 3 1/2" HINGES, SQUARE CO KNOBS: EMTEK ICE WHITE KNOBS. BACK PLATES: EMTEK QUINCY BACK PLATES. LATCH SET: EMTEK PRIVACY SET. HINGES: EMTEK 3 1/2" HINGES, SQUARE CO KNOBS: EMTEK ICE WHITE KNOBS. BACK PLATES: EMTEK QUINCY BACK PLATES. LATCH SET: EMTEK PASSAGE SET. SQUARE CORNERS, SQUARE CORNERS, BALL FINIALS, 3 PER LEAF BALL FINIALS, 3 PER LEAF.

BATH
SAME AS PRIVACY, ONLY WITH FINISH TO MATCH
PARTS VISIBLE INSIDE BATHROOM. HINGES: EMTEK 3 1/2" HINGES, SQUARE CORNERS, LATCH SET: DOUBLE DUMMY TRIM ON BOTH LEAVES. KNOBS: EMTEK ICE WHITE KNOBS.
BACK PLATES: EMTEK QUINCY BACK PLATES.
BALDWIN BALL CATCH AT TOP OF EACH LEAF. DOUBLE CLOSET PLUMBING FIXTURES ON ALL

BALL FINIALS, 3 PER LEAF 4 KNOBS TOTAL.

POCKET & DOUBLE POCKET
RAILS & CASTERS: JOHNSON 200PD POCKET DOOR SET.
EDGE & SURFACE SET: EMTEK MORTISED POCKET DOOR PASSAGE SET.

BATH <u>POCKET</u> SAME AS POCKET, ONLY WITH FINISH TO MATCH PLUMBING FIXTURES.

<u>BATH CLOSET</u> SAME AS PRIVACY, ONLY WITH FINISH TO MATCH PLUMBING FIXTURES.

NOTES

WALL STOPS: BALDWIN 4045.
FLOOR STOPS: BALDWIN 4510.
FINISHES: EMTEK: PEWTER
BALDWIN: ANTIQUE NICKEL
REJUVENATION: BRUSHED NICKEL
KEY ALL EXTERIOR DOORS ALIKE, ON ONE KEY.

49 LINDEN STREET ARLINGTON, MA 02476 781 643 0759

DAVID WHITNEY

GILBERT RESIDENCE 112 STOW STREET ACTON, MA 01720

ĦE:

Door & Hardware AS NOTED Schedules FILE: 5.21.13

DRAWN BY:

SHEET

DAVID WHITNEY AIA

Window Schedule

MARK	MANF	MODEL	OPERATION	R. O. SIZE		INSTALLATION HEIGHT	GLAZING PATTERN NOTES	NOTES
				WIDTH	HEIGHT			
≻	JELD WEN SITELINE	EWA3028	AWNING	2' - 6 3/4"	2' - 4 3/4"	ALIGN HEAD WITH BOTTOM OF SIDING	3W × 2H	
В	CUSTOM		FIXED	9' - 0"	1' - 6"	OVER GARAGE DOOR	8W × 2H	
С	JELD WEN SITELINE	EWD3136	DOUBLE HUNG	2' - 8 1/8"	3' - 0 3/4"	ALIGN TOP WITH TOP OF DOORS	3 OVER 1	
D	HARVEY	AWN31	AWNING	3' - 0 1/2"	2' - 0 1/2"	ALIGN TOP WITH TOP OF DOORS	3 OVER 1	
E	JELD WEN SITELINE	EWD3352	DOUBLE HUNG	2' - 10 1/8"	4' - 4 3/4"	ALIGN TOP WITH TOP OF DOORS	6 OVER 1	
F	SIMPSON	7010	FIXED	1' - 6"	6' - 8"	ALIGN TOP WITH TOP OF DOORS	2W × 5H	
G	JELD WEN SITELINE	EWD3344	DOUBLE HUNG	2' - 10 1/8"	3' - 8 3/4"	ALIGN TOP WITH TOP OF DOORS	6 OVER 1	
I	SIMPSON	7106	FIXED	2' - 6"	6' - 8"	ALIGN TOP WITH TOP OF DOORS	3W × 2H	TEMPERED GLASS

- 1. GANGED WINDOWS MAY BE MULLED TOGETHER IN THE FACTORY, BUT MUST PROVIDE STUD POCKET FOR (2) 2x STUDS PLUS SHIM SPACE BETWEEN ALL GANGED WINDOWS AS SHOWN IN ELEVATIONS.
- 2. SHOP DRAWING SUBMITTAL REQUIRED FOR ARCHITECT'S APPROVAL PRIOR TO ORDERING.
- 3. PROVIDE CLAD SASHES IN WOODEN FRAMES, WITH HISTORICAL SILLS AND HORNS TO MATCH EXISTING.
- 4. ALL INTERIOR FINISHES FACTORY PRIMED, PAINTED IN FIELD (EXCEPT HARVEY).
- 6. SCREENS: PROVIDE FULL SCREENS AT ALL OPERABLE UNITS.

5. EXTERIOR CASINGS 1x6 PLUS BROSCO 8462 BAND MOULDING. SEE ELEVATIONS.

- 7. HARDWARE: FINISH TO BE SPECIFIED.
- 8. GLAZING: CLEAR INSULATING LOW E GLASS, SIMULATED DIVIDED LITES (7/8" MUNTINS) WITH SPACER BARS.
- 9. WHITE JAMBLINERS AT ALL WINDOWS.
- NO FINGER PLOUGHS ON JELD WEN WINDOWS.

GILBERT RESIDENCE

49 LINDEN STREET ARLINGTON, MA 02476 781 643 0759 \cap DAVID WHITNEY

SCALE: AS NOTED

FILE: PLANS

Window Schedule

DAVID WHITNEY AIA

112 STOW STREET ACTON, MA 01720

Plumbing Schedule

					_				_			_		_		
				BATH 3				BATH 2			BATH 1		KITCHEN		LAUNDRY	ROOM
TUB/SHOWER SET	TUB	TOILET	LAV FAUCET	LAV	SHOWER SET	TOILET	LAV FAUCETS (2)	LAV (2)	TOILET	LAV FAUCET	LAV	FAUCET	SINK	FAUCET	SINK	ITEM
NEWPORT BRASS	тото	ТОТО	NEWPORT BRASS	KOHLER	NEWPORT BRASS	тото	NEWPORT BRASS	KOHLER	тото	NEWPORT BRASS	KOHLER	TO BE SPECIFIED. CARRY \$400 ALLOWANCE	KOHLER	TO BE SPECIFIED. CARRY	TO BE SPECIFIED. CARRY	MANUFACTURER
3-922BP	FBY1715LP	CST424EFG	920	K-2214 LADENA	3-924BP	CST424EFG	920	K-2214 LADENA	CST424EFG	920	K-2214 LADENA	\$400 ALLOWANCE.	K-6546-3-0	\$300 ALLOWANCE.	\$200 ALLOWANCE.	MODEL
SATIN NICKEL	COTTON	COTTON	SATIN NICKEL	WHITE	SATIN NICKEL	COTTON	SATIN NICKEL	WHITE	COTTON	SATIN NICKEL	WHITE		WHITE			COLOR/FINISH
	•	.9	œ) .	7	ق	•	ن	•	4.	ب	ıį	' د			

- CARRY MEDICINE CABINETS AS SHOWN IN INTERIOR ELEVATIONS IN BASE BID.
- BATH ACCESSORIES SUCH AS TOWEL BARS, PAPER HOLDERS, ETC. TO BE PROVIDED BY OWNERS. CARRY INSTALLATION & BLOCKING IN BASE BID. SEE INTERIOR ELEVATIONS.
- PROVIDE ALL ROUGH VALVES, SHUT-OFFS, ETC FOR ALL PRODUCTS LISTED IN SCHEDULE. SOME REQUIRED ROUGH PARTS MAY NOT APPEAR ON SCHEDULE.
- CARRY WATER TO FRIDGE.
- LOCATE HEIGHTS OF ALL SHOWER HEADS & VALVES IN FIELD WITH ARCHITECT & OWNERS.

- CARRY SHOWER CURTAIN RODS AND/OR SHOWER ENCLOSURES AS SHOWN IN INTERIOR ELEVATIONS IN BASE BID.
- CARRY TOILET SEATS BY TOILET MANUFACTURER FOR EACH TOILET IN BASE BID.
- PLAN ROUGH PLUMBING TO ACCOMMODATE RECESSED MEDICINE CABINETS AND SHELVES AT TUBS AND SHOWERS AS SHOWN IN PLANS AND INTERIOR ELEVATIONS.

- TUB & SHOWER DRAIN FINISHES TO MATCH PLUMBING FITTINGS.

DAVID WHITNEY R C H I T E C

49 LINDEN STREET ARLINGTON, MA 02476 781 643 0759

Insulation Schedule


LOCATION	TYPE	R VALUE	NOTES
MAIN ROOF	OPEN CELLED ICYNENE	R-38	AT ATTIC FLOOR, NOT ROOF
GARAGE ROOF	NONE		
ENTRY PORCH ROOF	NONE		
GARAGE EXTERIOR WALLS	NONE		
HOUSE EXTERIOR WALLS	OPEN CELLED ICYNENE	R-21	
INTERIOR WALLS	FIBERGLASS BATTS, NO FACING	R-11, R-19	R-11 AT 2x4 WALLS, R-19 AT 2x6 WALLS (FOR ACOUSTICS)
RIM JOISTS (ALL FLOORS) & SILLS	OPEN CELLED ICYNENE	R-21	TREAT LIKE EXTERIOR WALLS
FRAMED FLOORS	FIBERGLASS BATTS	R-30	FACING ONLY AT TOP OVER UNHEATED BASEMENTS
BASEMENT SLAB	RIGID INSULATION	R-10	UNDER SLABS — SEE DETAILS
AROUND WINDOW FRAMES	NON-EXPANDING FOAM		
UNDER BATHTUBS	FIBERGLASS BATTS		FOR ACOUSTICS
BETWEEN STAIR STRINGERS	FIBERGLASS BATTS		FOR ACOUSTICS


SCALE: AS NOTED Insulation Scheds Plumbing & DATE: 5.21.13


FILE:

GILBERT RESIDENCE 112 STOW STREET ACTON, MA 01720

DAVID WHITNEY AIA

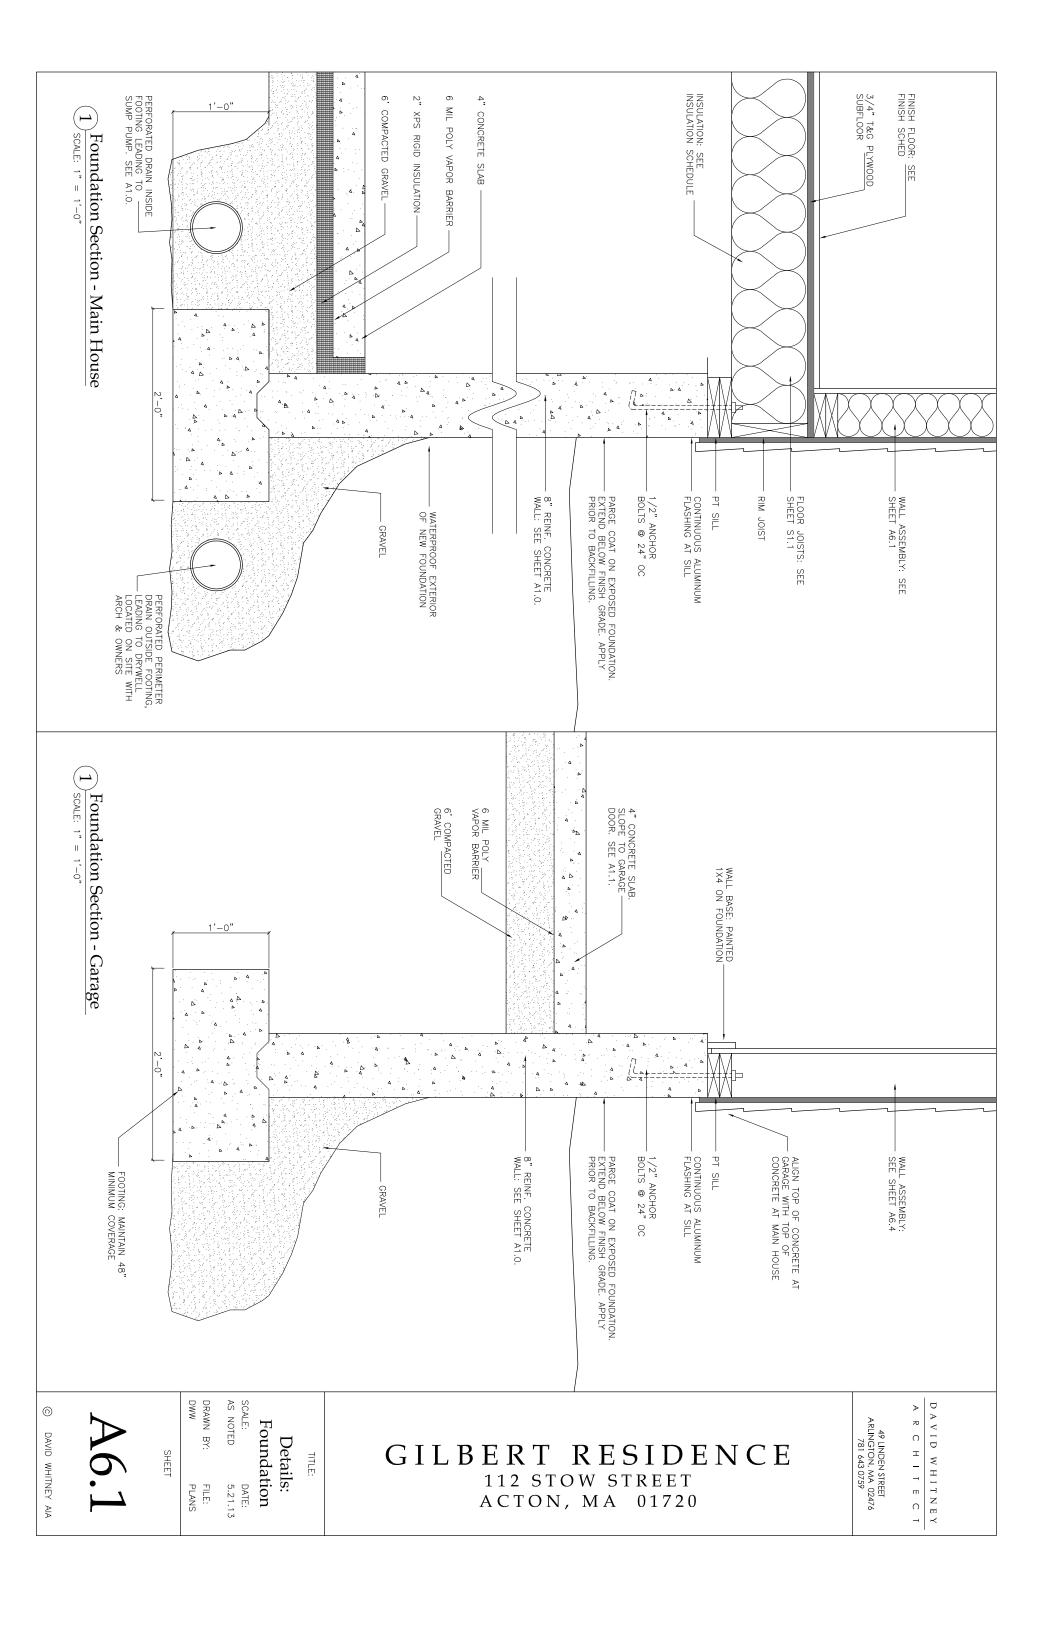


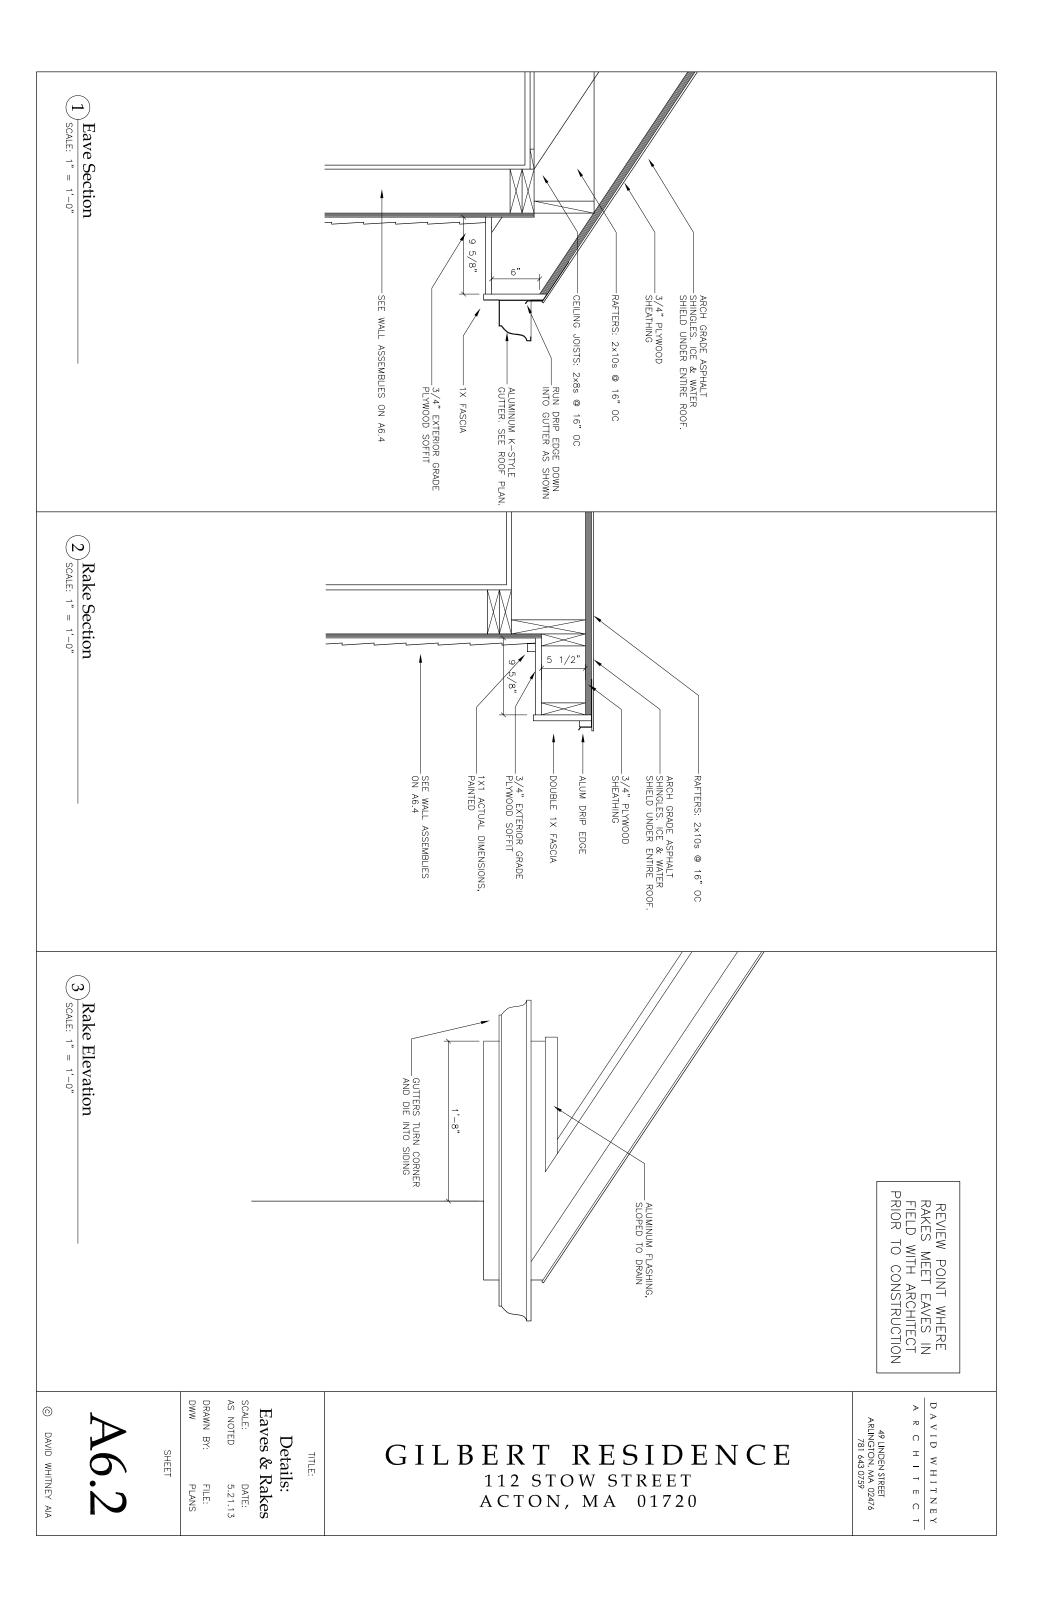


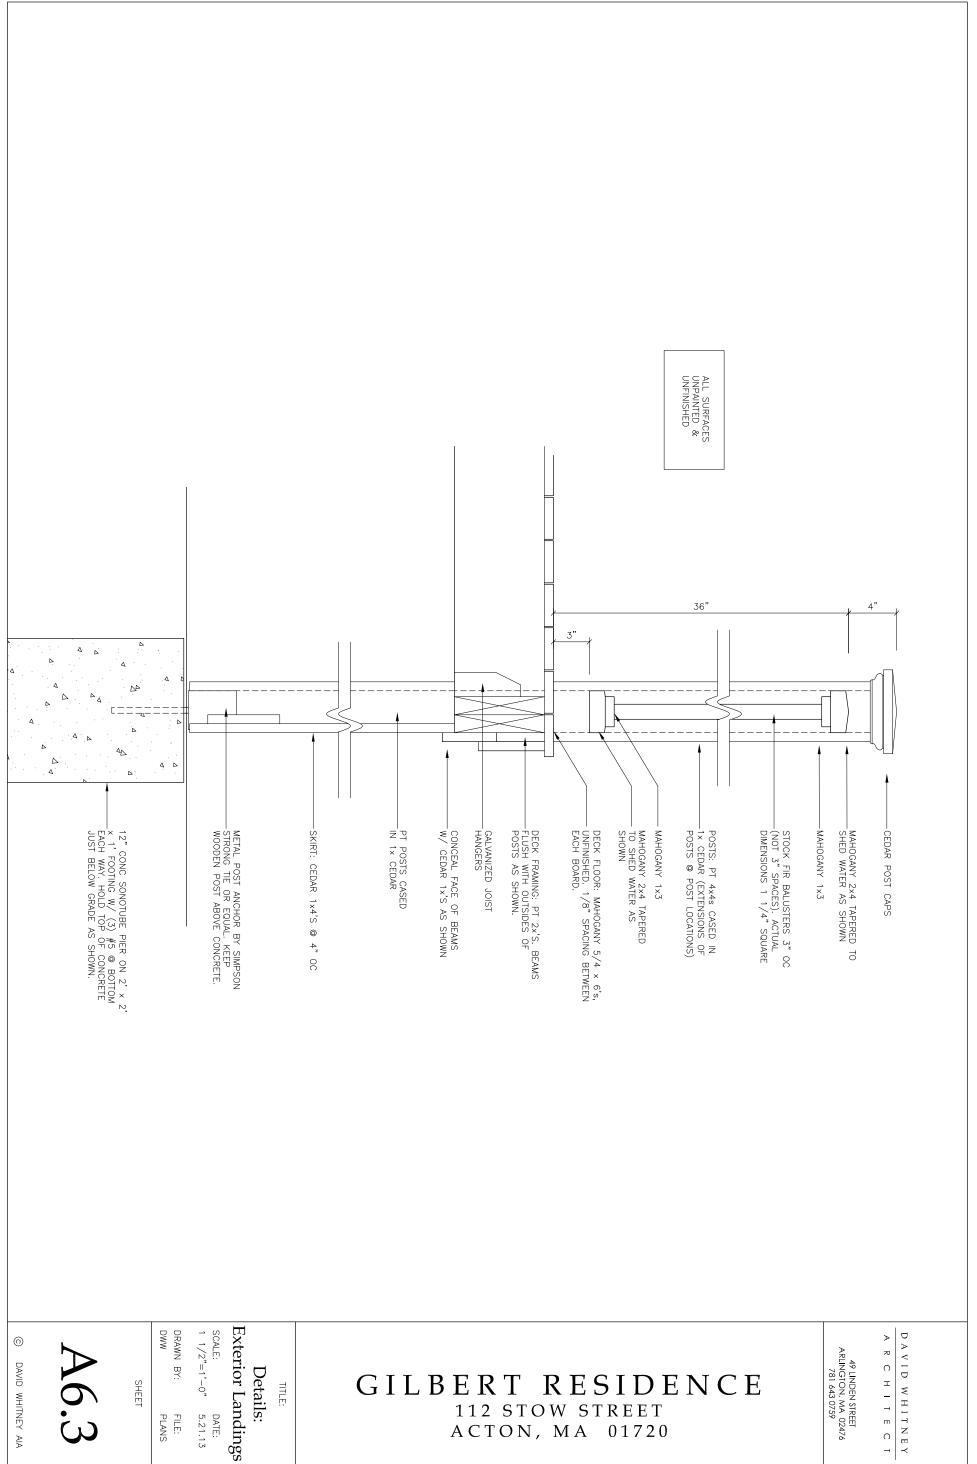

GILBERT RESIDENCE 112 STOW STREET ACTON, MA 01720

49 LINDEN STREET ARLINGTON, MA 02476 781 643 0759 R C H I T E C

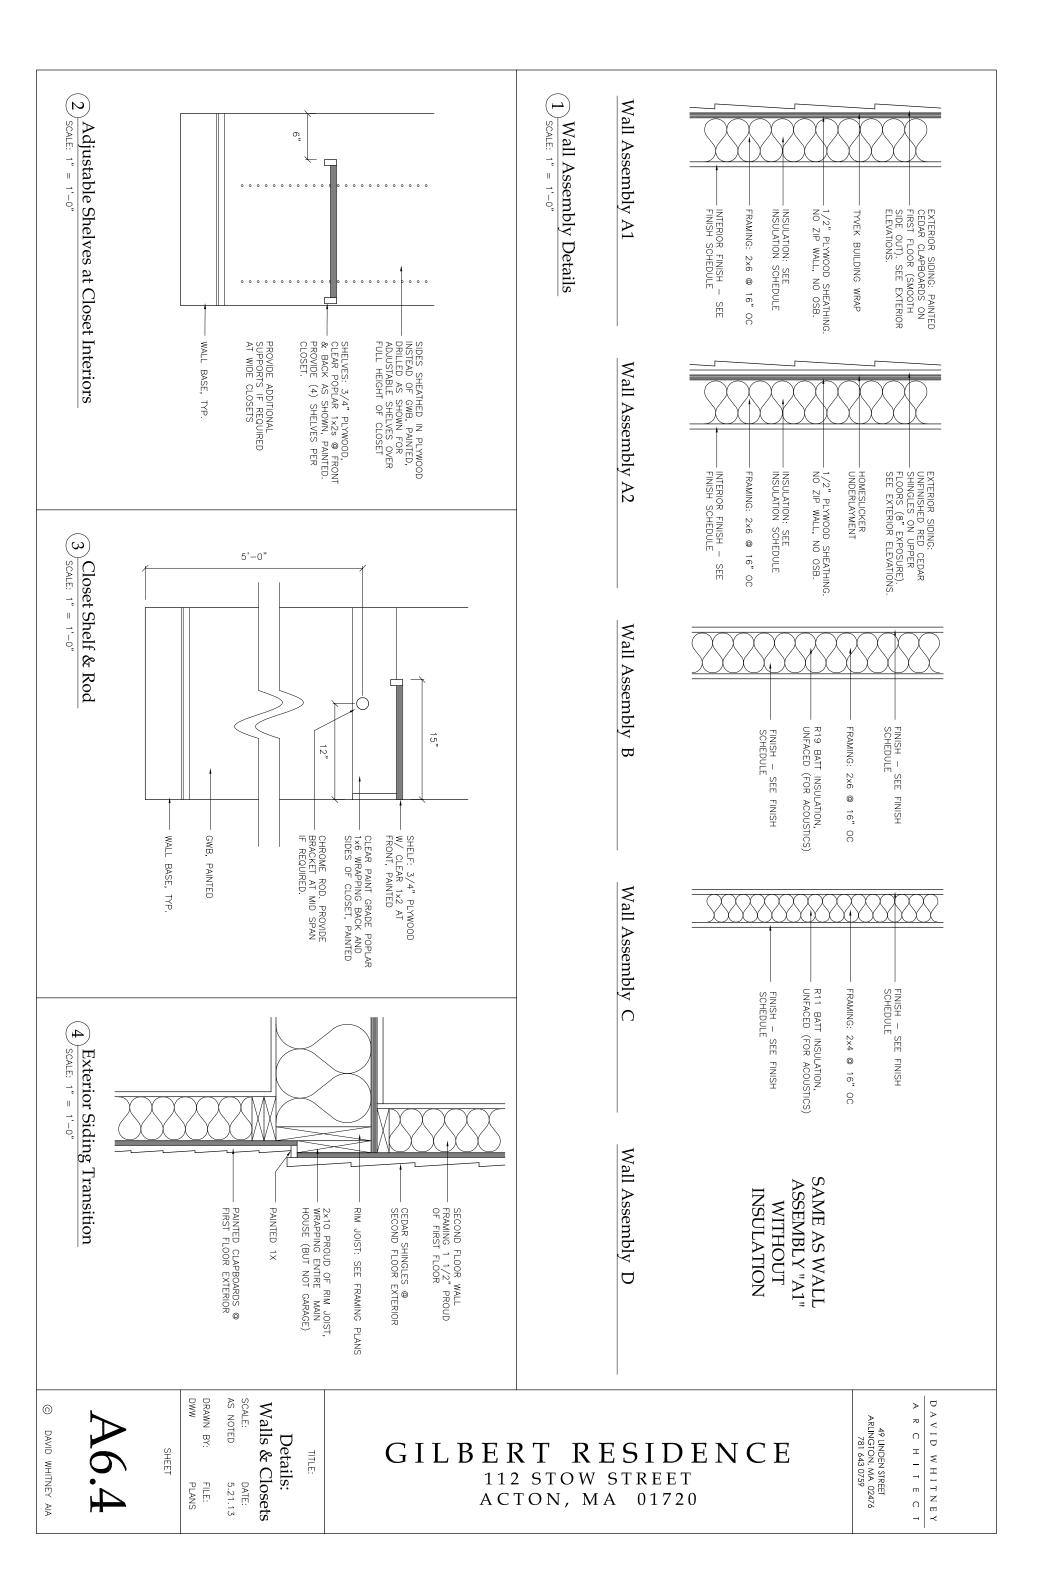

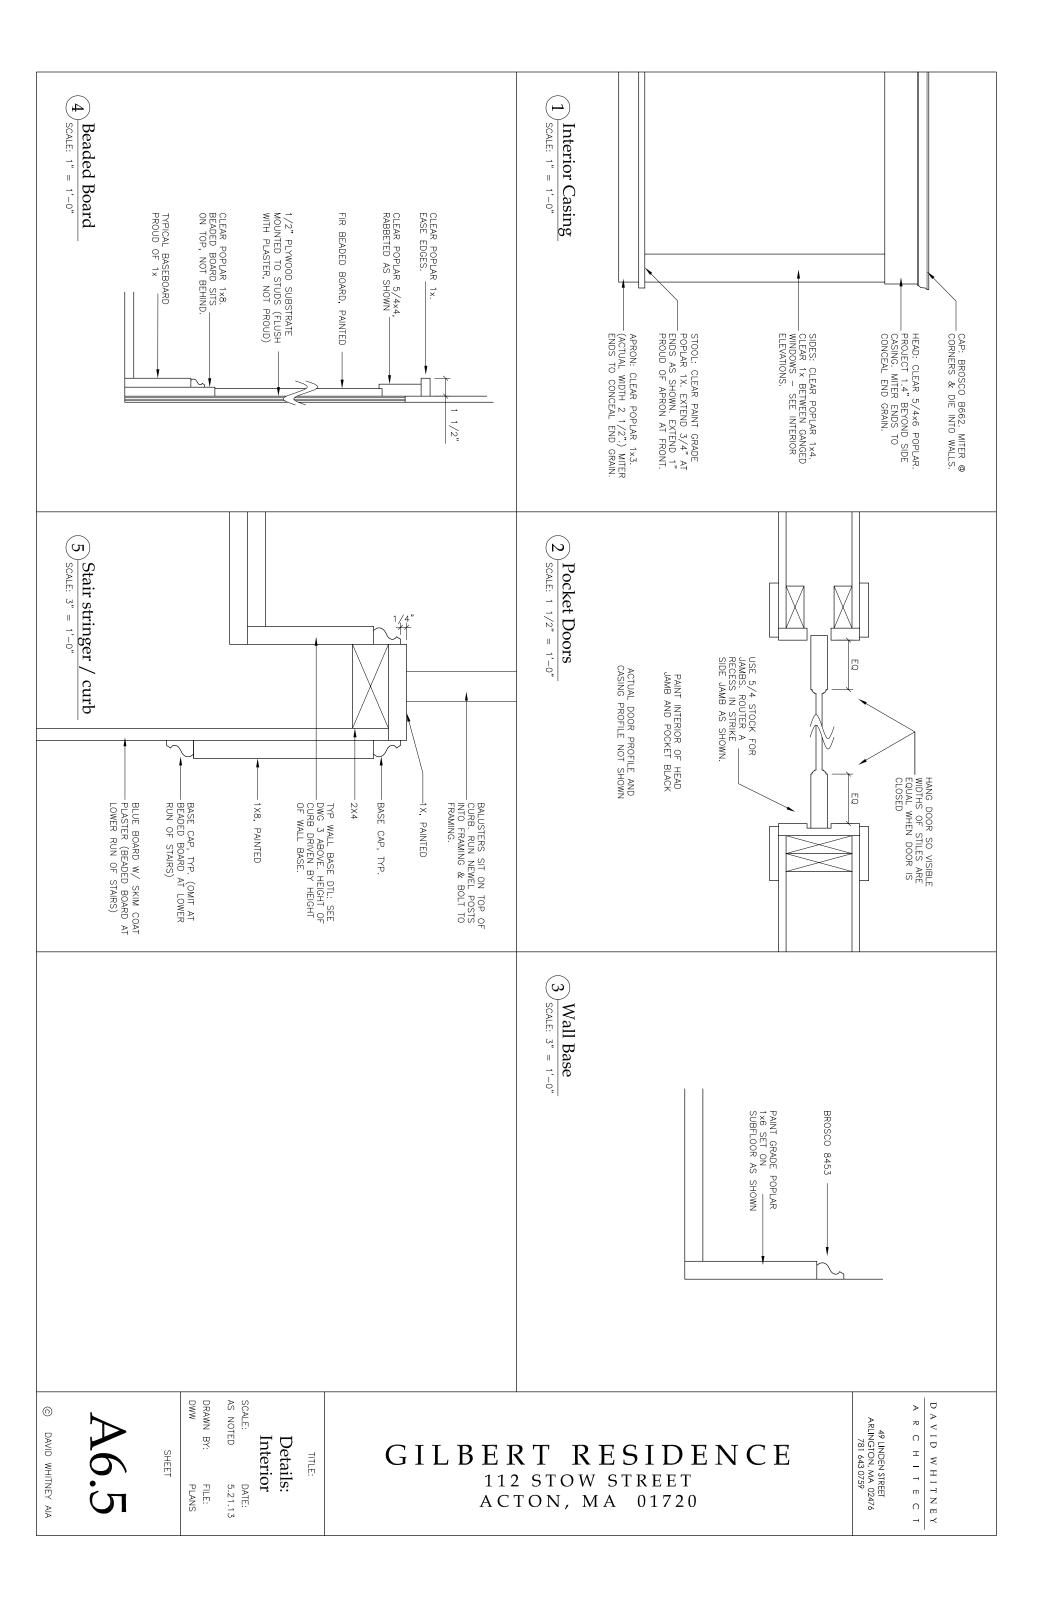

5'-0" 1'-4" 1 1/2" 1 1/2 EQ EQ EQ EQ ALL OPENING WIDTHS ARE ALL TO BE EQUAL. CUBBY NTERIOR AT RIGHT END WILL BE SLIGHTLY WIDER THAN OTHER INTERIORS. 3/4" PLYWOOD SIDES AND DIVIDERS 1X2 FACE FRAME AT ALL DIVIDERS. SEE ELEVATION. ALL SURFACES TO BE PAINTED 1/2" PLYWOOD BACK 1 1/2" Elevation 00 ΕQ Θ HOOKS TO BE
PROVIDED BY OWNERS
AND INSTALLED BY
CONTRACTOR 1X STOCK 3/4"

PROUD OF CUBBY

FACE FRAME BELOW 1X SKIRT RECESSED 3/4" FROM FACE CENTER RECEPTACLE IN EACH CUBBY EXTEND PLYWOOD BACK TO FLOOR DOOR HEAD CASING WRAPS TOP OF CUBBIES PROVIDE FLUSH TOP BEHIND MOLDING 1/2" PLYWOOD BACK 1X2 FACE FRAME 00 ΕQ 5'-0" 1/2" ΕQ \bigcirc 00 ΕQ 1 1/2" EQ 1'-1 1/2"

DAVID WHITNEY AIA

DRAWN BY:


SCALE: 1" = 1'-0"

DATE: 5.21.13

Details: Cubbies

GILBERT RESIDENCE


112 STOW STREET ACTON, MA 01720 49 LINDEN STREET ARLINGTON, MA 02476 781 643 0759 R C H I T E C

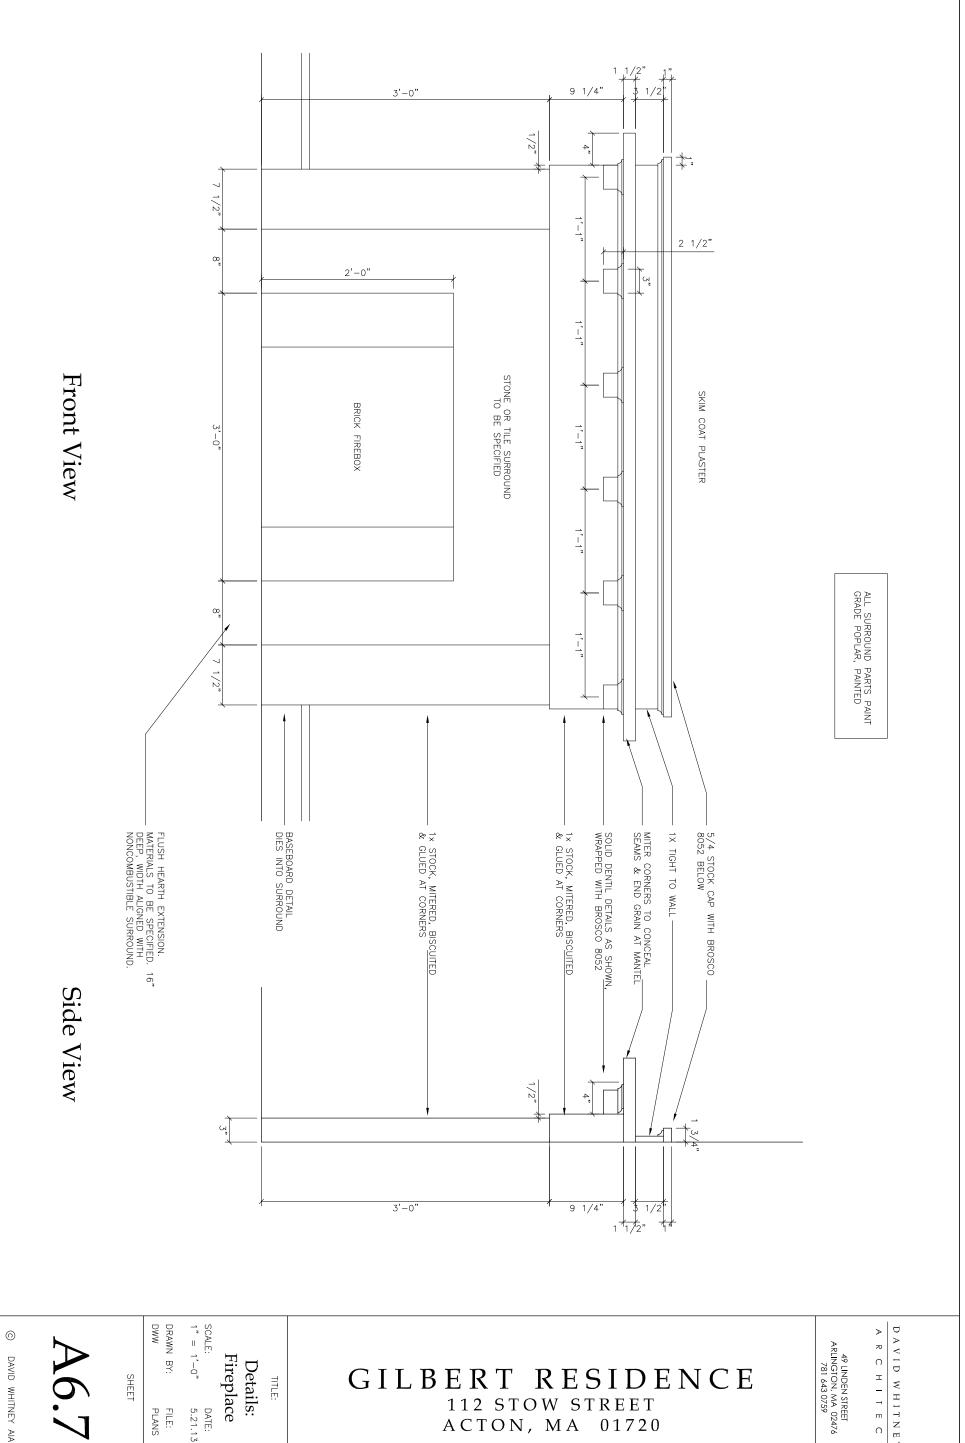

DATE: 5.21.13

GILBERT RESIDENCE

112 STOW STREET ACTON, MA 01720 49 LINDEN STREET ARLINGTON, MA 02476 781 643 0759 R C H I T E C

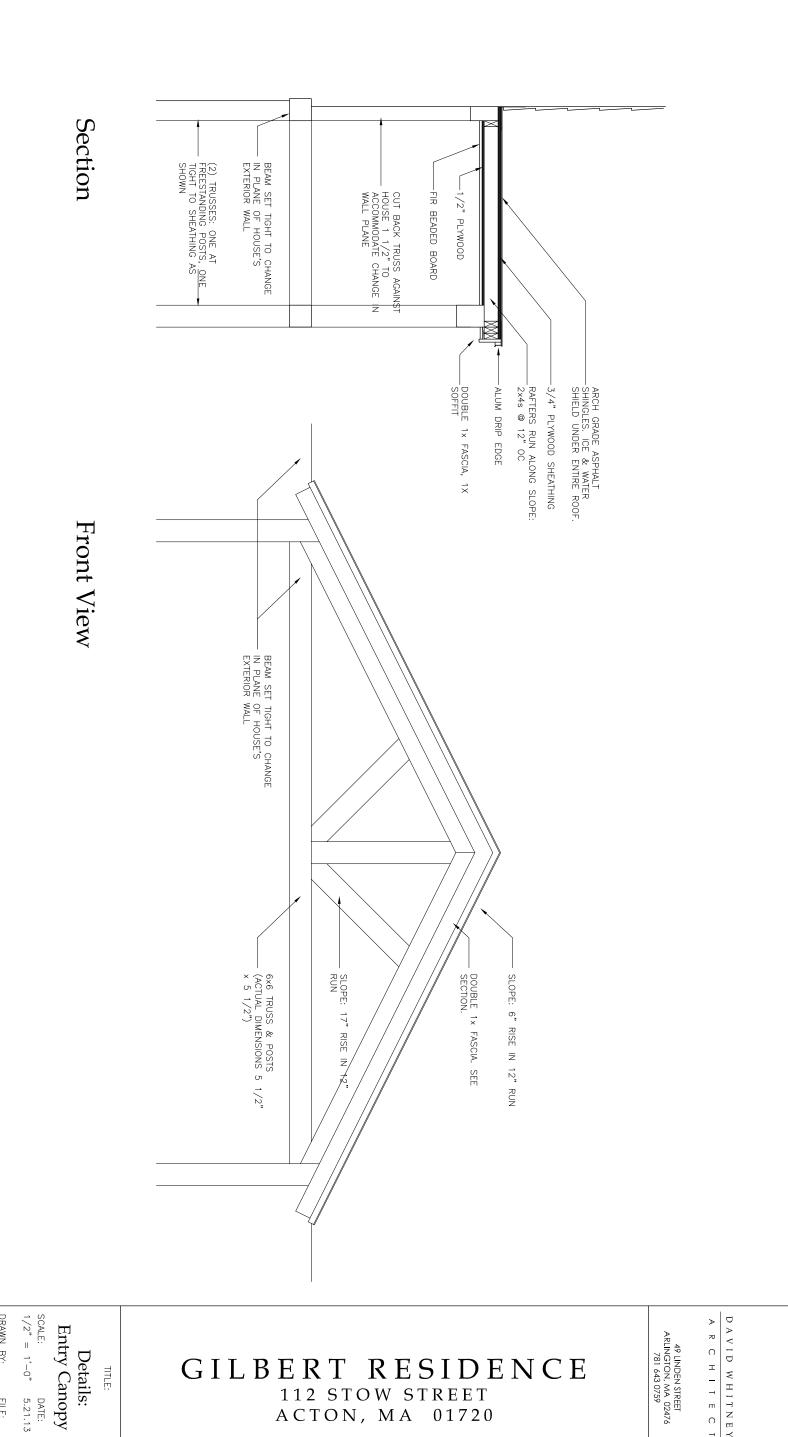

GILBERT RESIDENCE


112 STOW STREET ACTON, MA 01720 49 LINDEN STREET ARLINGTON, MA 02476 781 643 0759 R C H I T E C

SEE STRUCTURAL NOTES ON SHEET AO.1

CHECK JOIST LOCATIONS
AGAINST PLUMBING AND
RECESSED LIGHTS

WALLS. SEE PLANS & SHEET A6.1.

PROVIDE (2) 2x6 POST DOWN & (3) 2x8 HEADER AT EACH WINDOW & DOOR OPENING (NOT SHOWN). PROVIDE (2) 2x6s BETWEEN EACH GANGED WINDOW.

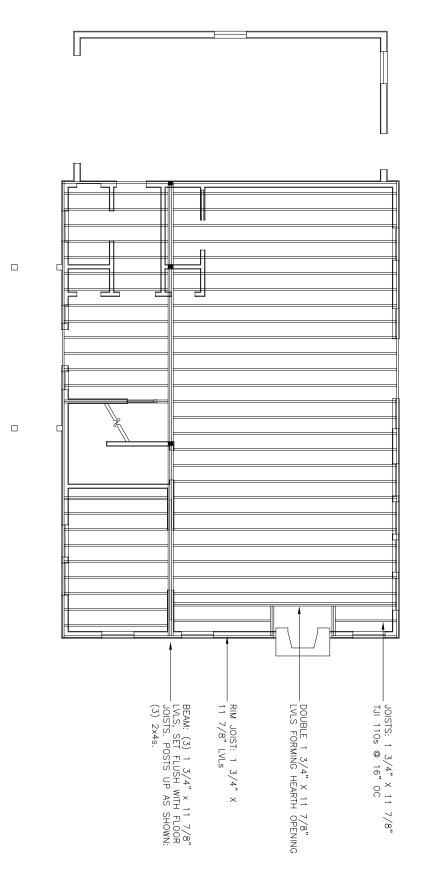



0

DAVID WHITNEY AIA

DRAWN BY:

FILE:

SHEET

SCALE: DATE: 1/8" = 1'-0" 5.21.13

First Floor Framing Plan

TITLE:

GILBERT RESIDENCE

112 STOW STREET ACTON, MA 01720


ARCHITEC 49 LINDEN STREET ARLINGTON, MA 02476 781 643 0759

DAVID WHITNEY

SEE WINDOW SCHEDULE FOR INSTALLATION HEIGHTS

CHECK JOIST LOCATIONS AGAINST PLUMBING AND RECESSED LIGHTS SEE STRUCTURAL NOTES ON SHEET AO.1 PROVIDE (2) 2x6 POST DOWN & (3) 2x8 HEADER AT EACH WINDOW & DOOR OPENING (NOT SHOWN). PROVIDE (2) 2x6s BETWEEN EACH GANGED WINDOW. WALLS. SEE PLANS & SHEET A6.1. DO NOT CANTILEVER GABLE END OF GARAGE RIM JOIST: 2×10s -JOISTS: 2×10s @ 16" OC, SET FLUSH WITH MAIN —— HOUSE 2ND FL JOISTS BEAM: (3) 1 3/4" x 11 7/8" LVLS, SET FLUSH WITH FLOOR JOISTS. POST DOWN AS SHOWN: (3) 2x4s. ATTIC FLOOR JOISTS IDENTICAL TO SECOND FLOOR FRAMING PLANS FUR OUT WALL WITHIN LANDING TO CONCEAL 1 1/2" CANTILEVER. REVIEW IN FIELD WITH ARCHITECT. CANTILEVER 2ND FLOOR 1 1/2" AT DRAWING EAST AND WEST. SEE DETAILS. RIM JOIST: 1 3/4" 11 7/8" LVLs JOISTS: 1 3/4" X 1: TJI 110s @ 16" OC CANTILEVER 2ND FLOOR 1 1/2" AT DRAWING NORTH AND SOUTH 1 7/8"

SEE WINDOW SCHEDULE FOR INSTALLATION HEIGHTS

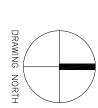

0

DAVID WHITNEY AIA

DRAWN BY: DWW

FILE: PLANS

SHEET

SCALE: DATE: 1/8" = 1'-0" 5.21.13

Second Floor Framing Plan

TITLE:

GILBERT RESIDENCE

112 STOW STREET ACTON, MA 01720 49 LINDEN STREET ARLINGTON, MA 02476 781 643 0759

DAVID WHITNEY ARCHITEC


CHECK JOIST LOCATIONS AGAINST PLUMBING AND RECESSED LIGHTS

SEE STRUCTURAL NOTES ON SHEET A0.1

LOAD BEARING WALLS. SEE PLANS & SHEET A6.1.

RAFTERS: 2×10s @ 16"
OC. PROVIDE COLLAR TIE
AT EACH RAFTER PAIR
(NOT SHOWN). RIDGE PLATE: 2×10 (NON LOAD BEARING RAFTERS: 2x10s @ 16"
OC. PROVIDE COLLAR TIE
AT EACH RAFTER PAIR
(NOT SHOWN). RIDGE PLATE: 2×10 (NON LOAD BEARING

SEE WINDOW SCHEDULE FOR INSTALLATION HEIGHTS

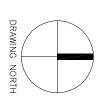

DAVID WHITNEY AIA

Roof Framing Plan

TITLE:

DRAWN BY:

FILE: PLANS

GILBERT RESIDENCE

112 STOW STREET ACTON, MA 01720

ARCHITEC 49 LINDEN STREET ARLINGTON, MA 02476 781 643 0759

I CTRIC ΑL Z IOTE

S

- PROVIDE HARDWIRED SMOKE DETECTION SYSTEM AS REQUIRED BY ALL APPLICABLE CODES. PUT SMOKE DETECTORS ON A DEDICATED & CLEARLY LABELED CIRCUIT. REVIEW LOCATION OF DETECTORS WITH ARCHITECT PRIOR TO INSTALLATION.
- PROVIDE RECESSED WATERPROOF RECEPTACLES WITH COVERS BY ARLINGTON INDUSTRIES OR APPROVED EQUAL AT ALL EXTERIOR LOCATIONS.

?

PROVIDE GFI RECEPTACLES AT ALL LOCATIONS REQUIRED BY CODE. WHITE BUTTONS.

Ÿ.

- PROVIDE INSULATED JUNCTION BOXES AT ALL EXTERIOR WALLS.
- ALL SWITCHES, RECEPTACLES, AND COVER PLATES WHITE. TRADITIONAL STYLE, NOT DECORA (EXCEPT GFI). DIMMER SWITCHES LUTRON ARIADNI.
- AT GANGED SWITCHES, POSITION SWITCHES IN SEQUENCES SHOWN IN DRAWINGS.

რ

'n

- 7. PROVIDE POWER FOR ALL KITCHEN APPLIANCES AS REQUIRED, AS SHOWN IN PLAN AND INTERIOR ELEVATIONS. ALL REQUIRED POWER MAY NOT BE SHOWN IN ELEC PLAN.
- PROVIDE NEW 200 AMP SERVICE.
- PROVIDE LOW VOLTAGE PANEL IN BASEMENT FOR LOW VOLTAGE CONNECTIONS: TELEPHONE, CABLE, ETC.

9. œ

10.

- CONDUIT: PROVIDE EMPTY 2" CONDUIT FROM BASEMENT TO ATTIC FOR POSSIBLE FUTURE USE. LOCATE & REVIEW IN FIELD WITH ARCHITECT & OWNERS.
- <u>-</u> PROVIDE SOLID STOCK FLASHED MOUNTING BLOCKS FOR ALL EXTERIOR LIGHTS. REVIEW IN FIELD WITH ARCHITECT.

[I] \Box I CTRICAL \Box I

 \Box П Z DS

- Ф DUPLEX RECEPTACLE
- -(S)-

- \bigcirc_{L}
- ₩ ₩
- A-TYPE BULB IN PORCELAIN SOCKET

 \Box

- QUAD RECEPTACLE

8

- Ş3 3 WAY SWITCH
- \$ DIMMER SWITCH: LUTRON ARIADNI
- EXHAUST FAN / LIGHT: PANASONIC FV-08VRL1. PROVIDE SEPARATE SWITCHES FOR LIGHT AND FAN. REVIEW DUCT RUNS AND EXTERIOR VENT LOCATIONS IN FIELD WITH ARCHITECT.

- RECESSED FIXTURE
 HALO H991CT HOUSING
 HALO 993 WHITE BAFFLE & TRIM RING
 HALO 993 WHITE BAFFLE & TRIM RING
 HALO 995 WHITE BAFFLE WHITE BAFFLE
- œ SURFACE MOUNTED FIXTURE: TO BE PROVIDED BY OWNER & INSTALLED BY CONTRACTOR.
- CLOSET LIGHT COMPACT FLUORESCENT SUBMITTAL REQUIRED
- UNDER CABINET XENON LIGHT FIXTURE
 SEAGULL LIGHTING
 MODELS 98018-15 TO 98020-15 (LENGTHS VARY)

- FLUORESCENT UTILITY LIGHT SUBMITTAL REQUIRED

- TELEPHONE RECEPTACL E: CAT 6E CABLE, HOME PANEL IN BASEMENT.
- 9 DOOR BELL BUTTON TO BE SPECIFIED FINISH TO MATCH DO DOOR HARDWARE

DB

- GARAGE DOOR OPENER SUBMITTAL REQUIRED
- MOTION DETECTOR

MD

CABLE TV RECEPTACLE. HOME RUN TO LOW VOLTAGE PANEL IN BASEMENT.

abla

 \bigcirc

DOOR BELL CHIME TO BE SPECIFIED

(1)

CEILING FAN / LIGHT TO BE PROVIDED BY OWNER AND INSTALLED BY CONTRACTOR

유 CEILING FAN / LIGHT CONTROLS TO BE PROVIDED BY OWNER AND INSTALLED BY CONTRACTOR

(3)

GARAGE DOOR BUTTON SUBMITTAL REQUIRED

GD

THESE ARE STANDARDIZED ELECTRIC LEGENDS FOR GENERAL USE. ALL ITEMS MAY NOT APPEAR IN THIS PROJECT.

49 LINDEN STREET ARLINGTON, MA 02476 781 643 0759

DAVID WHITNEY

GILBERT RESIDENCE 112 STOW STREET ACTON, MA 01720

DRAWN BY:

PLANS FIE

SHEET

AS NOTED


5.21.13


Notes & Legends

Electric

THE:

0 DAVID WHITNEY AIA

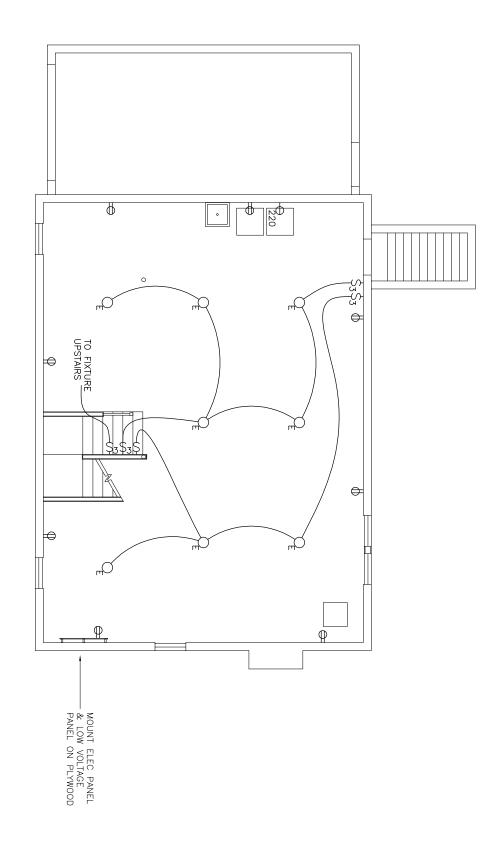

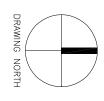


DRAWN BY: DWW


SCALE: DATE: 1/8" = 1'-0" 5.21.13 Basement Electric Plan

GILBERT RESIDENCE

112 STOW STREET ACTON, MA 01720

ARCHITEC 49 LINDEN STREET ARLINGTON, MA 02476 781 643 0759

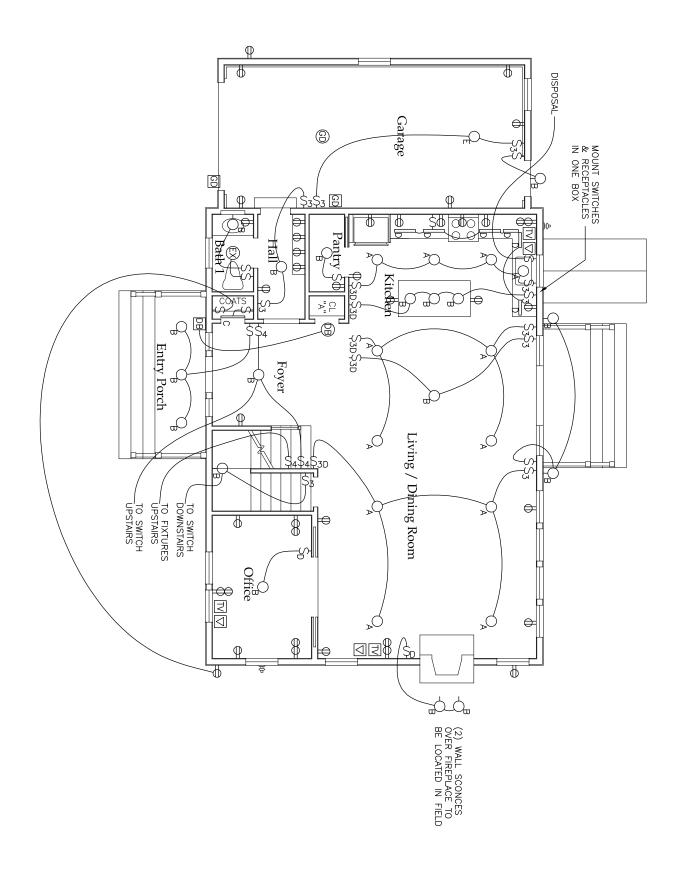

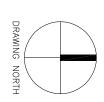


DRAWN BY:

SCALE: DATE: 1/8" = 1'-0" 5.21.13 Electric Plan First Floor

GILBERT RESIDENCE

112 STOW STREET ACTON, MA 01720 49 LINDEN STREET ARLINGTON, MA 02476 781 643 0759

R C H I T E C

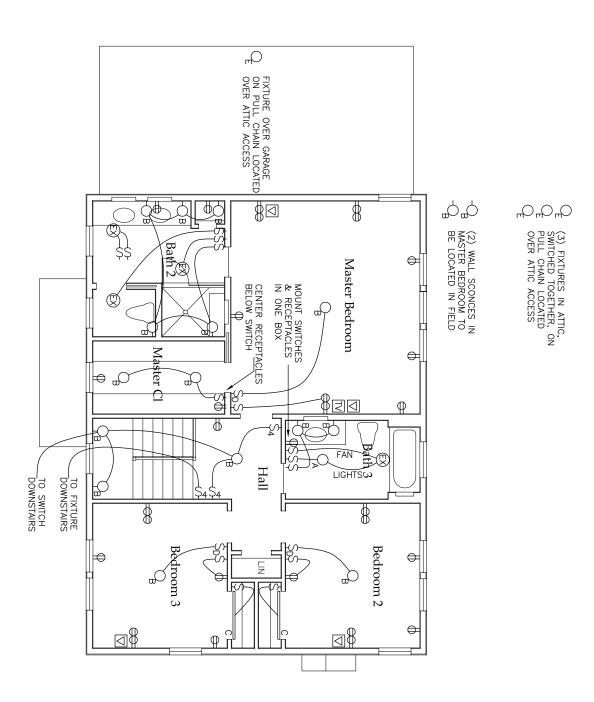



DRAWN BY: SCALE: DATE: 1/8" = 1'-0" 5.21.13 Second Floor Electric Plan

IIIE:

GILBERT RESIDENCE

112 STOW STREET ACTON, MA 01720 49 LINDEN STREET ARLINGTON, MA 02476 781 643 0759 R C H I T E C